

LOCATION MAP

SCALE: not to scale

LANDSCAPE ARCHITECT:



uplandDesign ltd

Landscape Architecture & Park Planning 1229 N. North Branch St, #220A, Chicago, IL 60642 24042 Lockport St, Plainfield, IL 60544 312-350-4088 | 815-254-0091 uplandDesign.com

IL License 060-007797

CIVIL ENGINEERING:



Engineering Resource Associates 3s701 West Avenue, Suite 150 Warrenville, IL 60555 IL License # 184-001186

SURVEYOR JLH Land Surveying inc. 910 Geneva St. Shorewood, Illinois 60404 Phone: 815-729-4000 ILicense: 184-007120





21W730 Butterfield Rd Lombard, IL 60148

Partially Funded by Illinois Department of Natural Resources OSLAD Grant No. OS 22-2167

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Butterfield Park District

NCE

uthwest site landscape and irrigation ork, restoration and any other tree inting as noted shall be completed by vember 15, 2023.

rthwest development shall be bstantially completed by June 1, 2024

Heath A. Wright # 157.000994 Elizabeth A. Dafoe # 157.00157

REVIS	()	NS	

ORIGINAL ISSUE DATE **Issue for Permit** 17JUL2023

PROJECT NUMBER 999-1117

PROJECT NAME

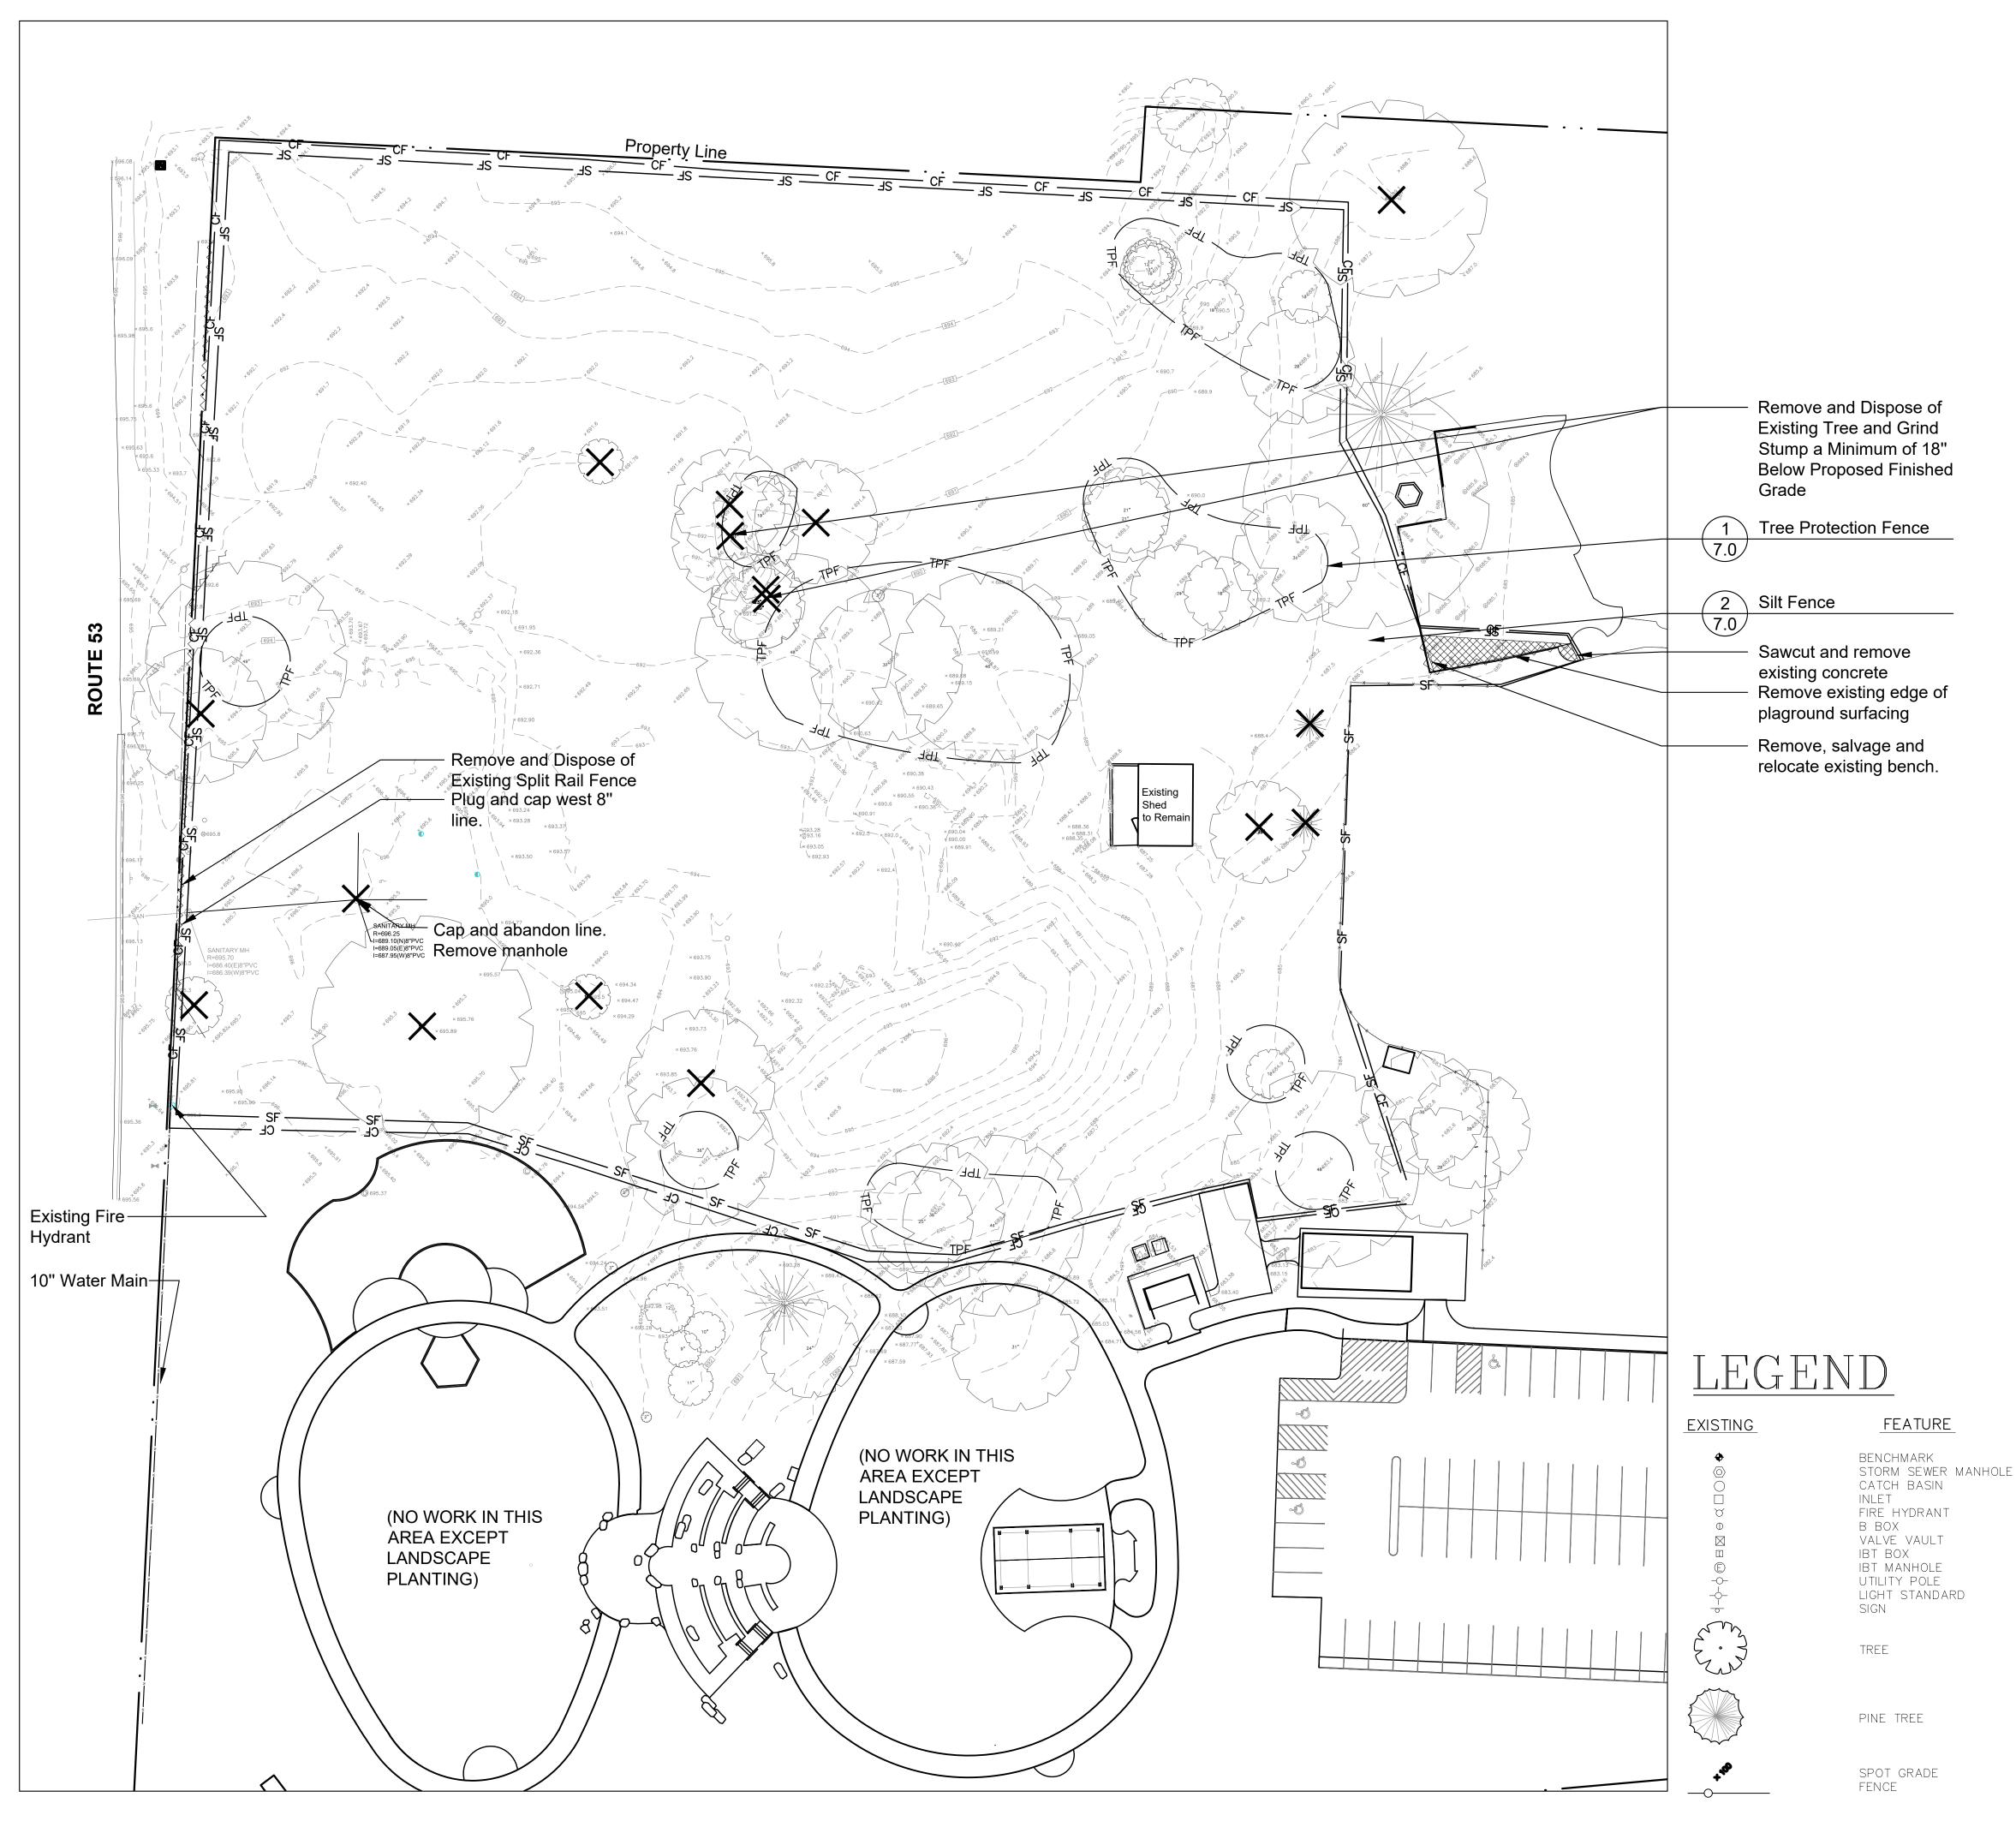
Glenbriar Park Phase III

SHEET TITLE

Title Sheet

SHEET NUMBER

1.0





GENERAL NOTES: EXISTING CONDITIONS & REMOVALS

- 1. The Contractor is to locate all utilities, public and private, prior to beginning construction. Contractor will be responsible for any damages to utilities caused by their work. Contact J.U.L.I.E. 72 hours prior to construction at 1-800-982-0123 or (811) for location of utilities and contractor shall be responsible for protection of the same.
- Site conditions are shown based upon available information, contractor to verify all existing 2 conditions prior to bidding.
- The contractor shall be responsible for the protection of all private utilities even though they may not be shown on the plans. Any utility damaged during the construction shall be repaired or replaced to the satisfaction of the Owner at the contractor's expense. No tree shall be planted within 10 lateral feet of any underground waterline, sewer line, transmission line or other utility.
- Contours and elevations shown hereon are referenced to the North American vertical datum of 1988 (navd88)
- 5. A Topographic Survey was completed for the Owner by: Zeitler Consulting Inc.
 - 1130 Randville, Unit 2B
 - Palatine, Illinois 60074 Phone: 224-220-6030
- The Contractor shall walk the site prior to submitting a bid to be fully familiar with site conditions.
- The Contractor shall protect and preserve all section, property or survey reference markers. Tree Protection Fence to be installed as shown on plans and details prior to beginning construction. (incidental to cost). Do not drive, store equipment or materials within dripline of existing trees that are to be saved. Hold necessary disturbance to a minimum.
- Contractor will be held responsible for damage to items not scheduled for removal.
- 10. Contractor shall repair or replace all damaged sidewalks, curbs or paving to remain in place that were damaged as a result of work stated in contract documents. 11. No excavations are to be left open to foul weather, rain, snow, etc. which would necessitate
- further excavation and additional sub grade materials. 12. Work site safety is the responsibility of the Contractor.
- Vehicular Construction access shall be at one location to minimize damage. Construction 13. access shall be approved by the Owner's representative.
- 14. <u>Construction Limits</u>: Construction Limits are as noted on plans. Do not store equipment or stockpile materials outside of construction limits. Any areas disturbed as a result of construction shall be restored to lawn or other surface by contractor to match pre-construction condition.
- 15. Topsoil may be stockpiled for redistribution as needed. Excess topsoil, debris and plant material to be removed off site and disposed of legally.
- 16. Construction fence shall be installed prior to beginning construction. Construction fence to be free standing chainlink. (incidental to contract). 17. Place erosion control measures as required to eliminate sedimentation into non-construction
- areas and as shown on plans and details prior to beginning construction. 18. Before beginning work at the site and throughout the course of the work contractor to inspect
- and verify the location and condition of every item affected by the work under this contract and report discrepancies to the Owner's Representative before beginning work. Should discrepancies appear among the contract documents or between the contract 19.
- documents and existing conditions, the contractor shall request an interpretation from the Owner's Representative before bidding. If the contractor fails to make such requests, it is presumed that both provisions were included in the bid, and the Owner's Representative shall determine which of the conflicting requirements shall govern. The contractor shall perform the work at no additional cost to the Owner in accordance with the Owner's Representative determination. Where conflicts exists between or within the contract documents between and applicable standards, codes, ordinances or manufacturers recommendations, and clarification has not been requested from the Owner's Representative prior to bidding as provided for above, the more stringent or higher quality standard shall prevail. Large scale drawings shall take precedence over small scale drawings, figured dimensions on the drawings over scaled dimensions and noted material over graphic representations.
- The contractor shall provide all work and materials which any section or part of the drawings, specifications or conditions require them to provide, regardless of whether such requirement is or is not faithfully repeated in other parts of the documents thereof to which the provisions might be appropriate.
- 21. All necessary site work permits will be obtained by Owner. Contractor and all subcontractors shall register and pay associated fees to the Building Department. Contractor is responsible for following permit requirements including coordination of inspections and/or reinspections and associated fees.
- 22. Contractor shall follow all permit requirements as part of the project.

PROJECT BENCHMARK

DUPAGE COUNTY AREA BENCHMARK: SITE BENCHMARK:

IDOT BENCHMARK M125001 BRONZE DISK MONUMENT ON TOP OF CONCRETE HEADWALL AT THE SOUTHWEST CORNER OF THE ROADWAY BRIDGE OF IL-56 (BUTTERFIELD RD OVER THE EAST BRANCH OF THE DUPAGE RIVER

CP-102 MMAG NAIL IN ASPHALT AT NORTHWEST CORNER OF PARKING LOT

ELEVATION = 683.44

ELEVATION = 681.14

REMOVALS LEGEND

Remove and Dispose of Existing Fence



Remove and properly dispose of trees, stump, and grind root mass to a depth of 18" below existing grade or proposed grade which ever is lowest unless otherwise noted on plan.



Remove and Dispose of Item as Marked

Salvage and Relocate Item as Marked



21W730 Butterfield Rd Lombard, Illinois 60148 Phone: 630-858-2229

PROJECT

Glenbriar OSLAD Phase III Development

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ENGINEER

Engineering Resource Associates 3S701 West Avenue Suite 150 Warrenville, IL 60555 Phone: 630-393-3060

SURVEYOR


Zeitler Consulting, Inc. 1130 Randville, Unit 1B Palatine, Illinois 60074 Phone: 224-220-6030

SHEET TITLE Existing



DRAW / REVISION

LD/JF	Issue for Permit	17JUL2023

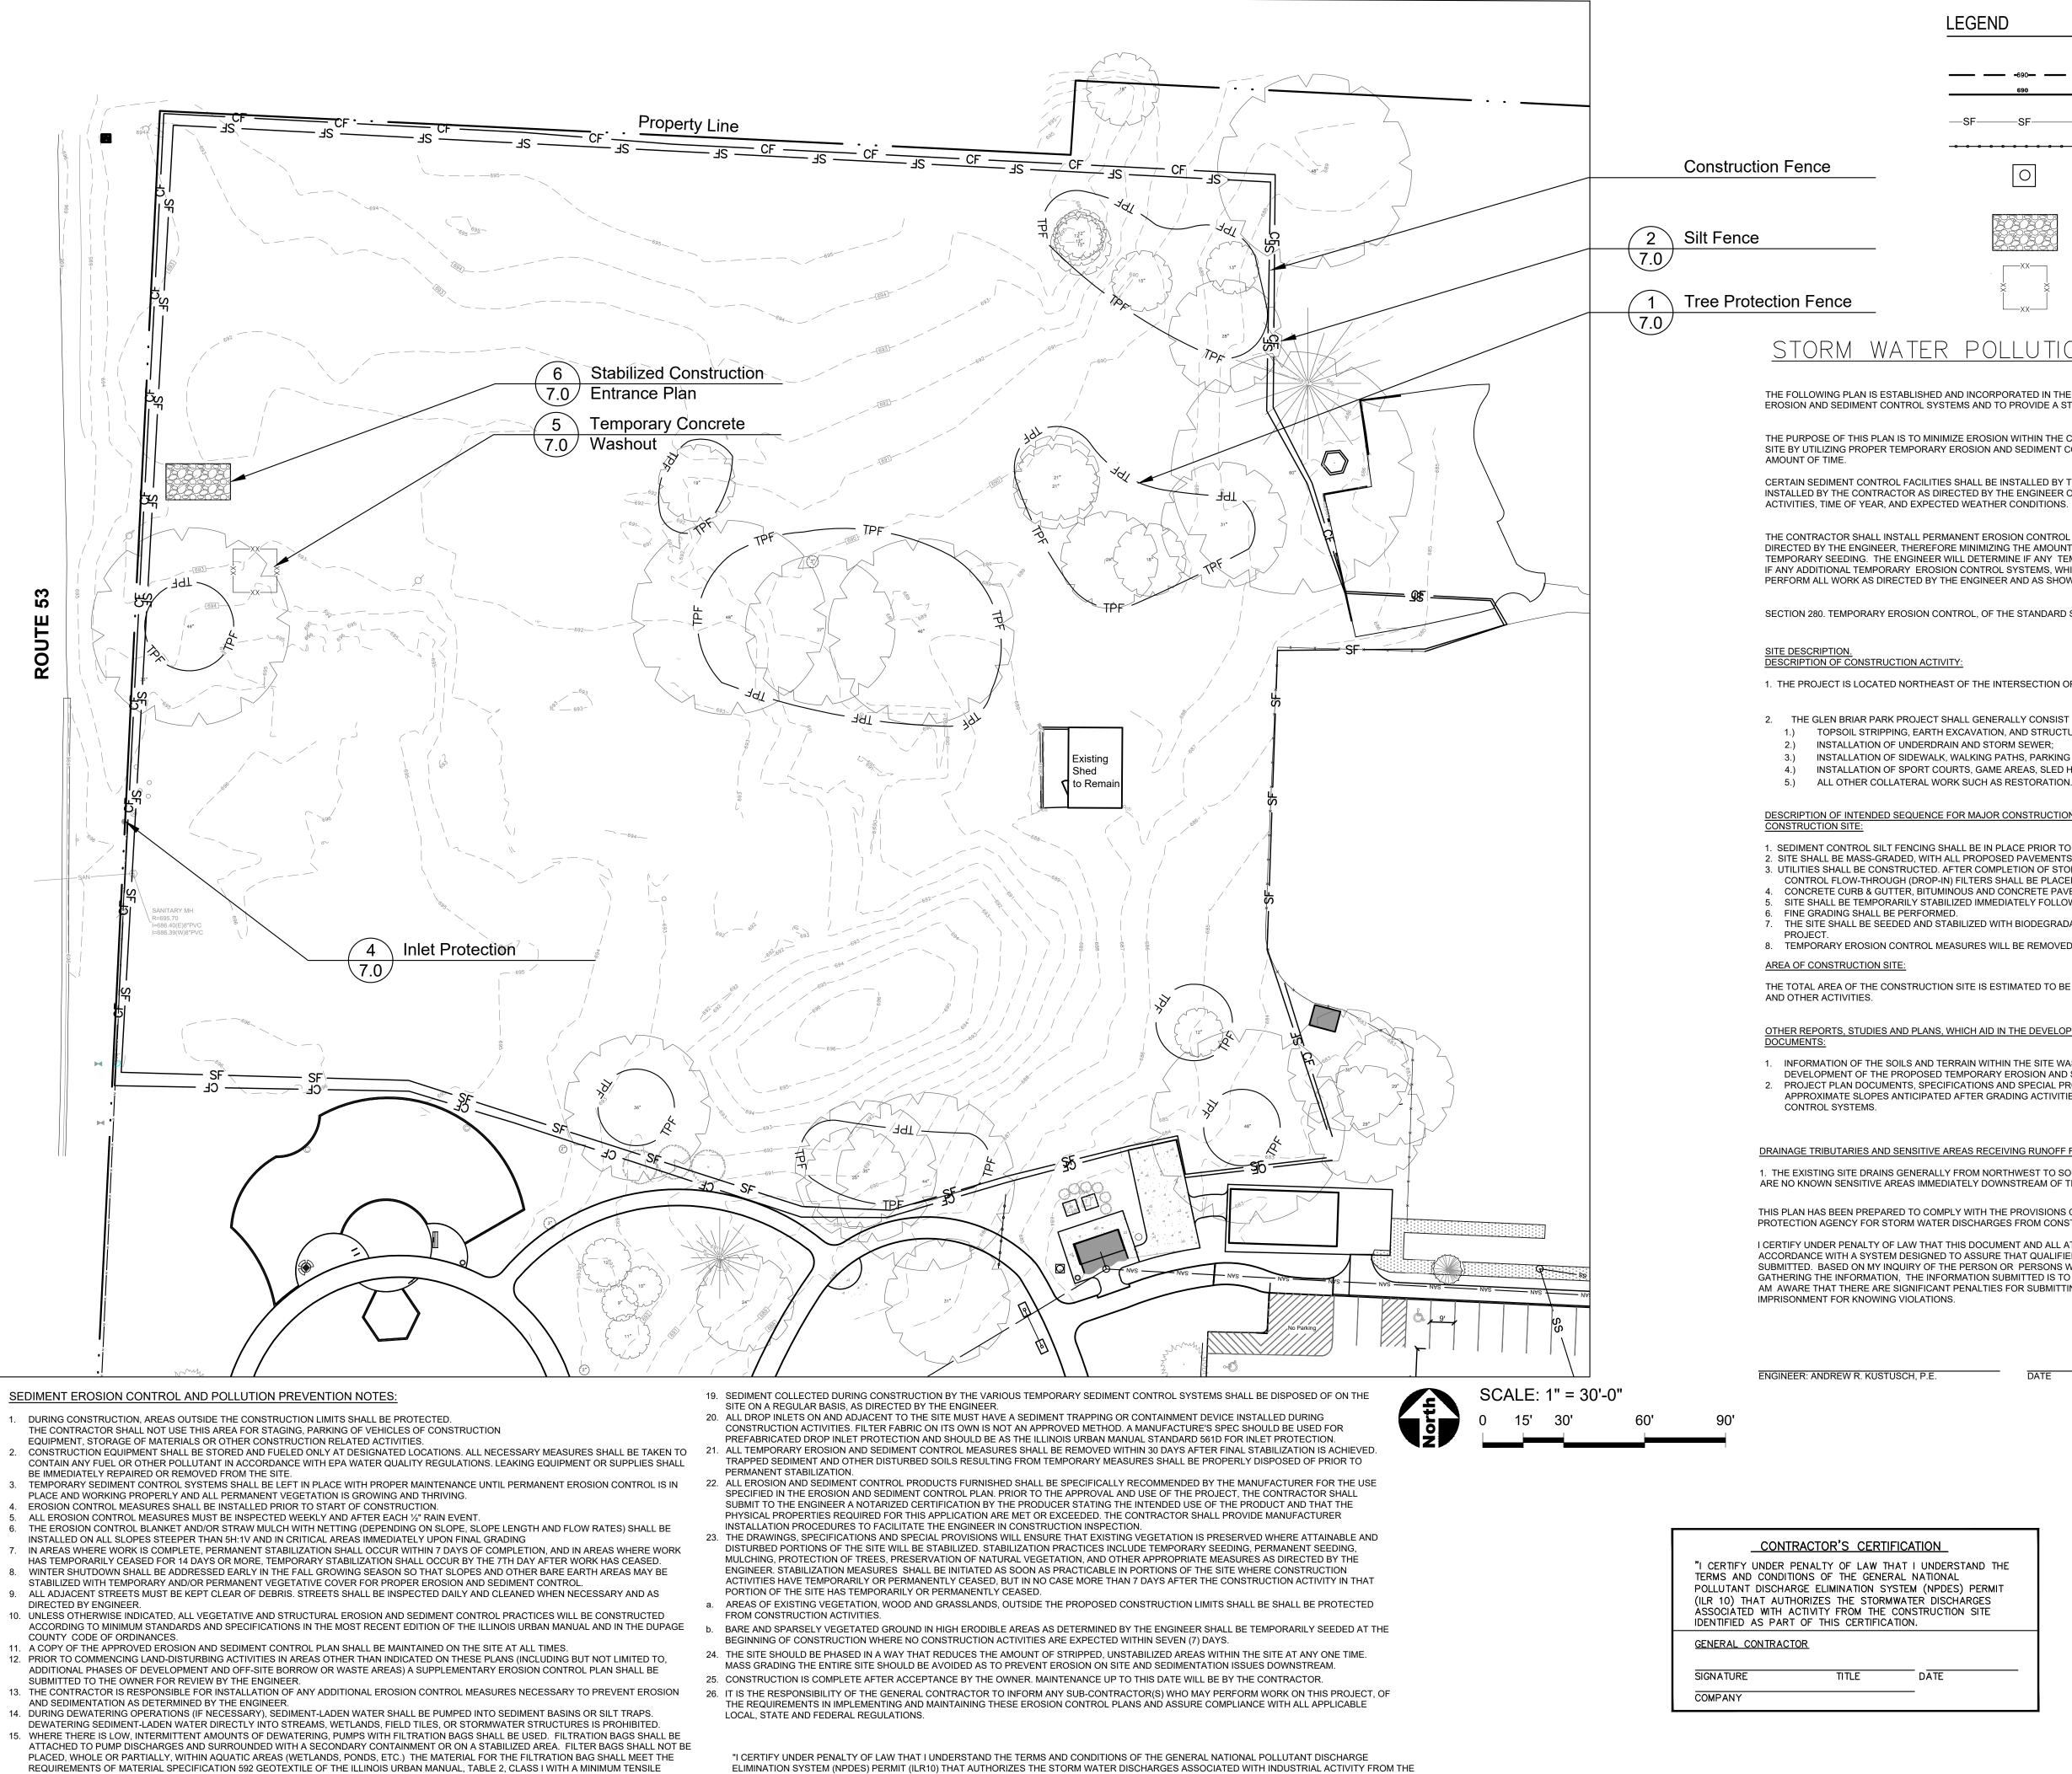

- STRENGTH OF 200 LBS. THE FILTRATION BAG SHALL BE SIZED PER MANUFACTURER RECOMMENDATIONS AND BASED ON THE SIZE OF THE PUMP. 16. EXCAVATED AREAS SHALL BE PERMANENTLY SEEDED IMMEDIATELY AFTER FINAL GRADING. IF NOT, THEY SHALL BE TEMPORARILY SEEDED IF NO CONSTRUCTION ACTIVITY IN THE AREA IS PLANNED FOR SEVEN (7) DAYS. 17. TEMPORARY EROSION CONTROL SEEDING SHALL BE APPLIED AT A RATE OF 100 LBS/ACRES.
- 18. STOCKPILES THAT ARE TO REMAIN IN PLACE MORE THAN THREE DAYS SHALL BE PROVIDED WITH SOIL EROSION AND SEDIMENT CONTROL MEASURES.

CONSTRUCTION SITE IDENTIFIED AS PART OF THIS CERTIFICATION."

LEGEND

	-690	
	690	
—SF—	SF	—SF—
<u> 0 0 0 0 0</u>	0	-00

EXISTING CONTOUR PROPOSED CONTOUR SINGLE ROW SILT FENCE ROLLED EROSION CONTROL DITCH CHECK INLET AND PIPE PROTECTION

TEMPORARY CONSTRUCTION ENTRANCE

CONCRETE WASHOUT

STORM WATER POLLUTION PREVENTION PLAN

THE FOLLOWING PLAN IS ESTABLISHED AND INCORPORATED IN THE PROJECT TO DIRECT THE CONTRACTOR IN THE PLACEMENT OF TEMPORARY EROSION AND SEDIMENT CONTROL SYSTEMS AND TO PROVIDE A STORM WATER POLLUTION PREVENTION PLAN FOR COMPLIANCE UNDER NPDES.

THE PURPOSE OF THIS PLAN IS TO MINIMIZE EROSION WITHIN THE CONSTRUCTION SITE AND TO LIMIT SEDIMENT FROM LEAVING THE CONSTRUCTION SITE BY UTILIZING PROPER TEMPORARY EROSION AND SEDIMENT CONTROL SYSTEMS AND PROVIDING GROUND COVER WITHIN A REASONABLE

CERTAIN SEDIMENT CONTROL FACILITIES SHALL BE INSTALLED BY THE CONTRACTOR AT THE BEGINNING OF CONSTRUCTION. OTHER ITEMS SHALL B INSTALLED BY THE CONTRACTOR AS DIRECTED BY THE ENGINEER ON A CASE BY CASE SITUATION DEPENDING ON THE CONTRACTOR'S SEQUENCE OF ACTIVITIES. TIME OF YEAR. AND EXPECTED WEATHER CONDITIONS.

THE CONTRACTOR SHALL INSTALL PERMANENT EROSION CONTROL SYSTEMS AND SEEDING WITHIN A TIME FRAME SPECIFIED HEREIN AND AS DIRECTED BY THE ENGINEER. THEREFORE MINIMIZING THE AMOUNT OF AREA SUSCEPTIBLE. TO EROSION AND REDUCING THE AMOUNT OF EMPORARY SEEDING. THE ENGINEER WILL DETERMINE IF ANY TEMPORARY EROSION CONTROL SYSTEMS SHOWN IN THE PLAN CAN BE DELETED AN IF ANY ADDITIONAL TEMPORARY EROSION CONTROL SYSTEMS, WHICH ARE NOT INCLUDED IN THIS PLAN. SHALL BE ADDED. THE CONTRACTOR SHALL PERFORM ALL WORK AS DIRECTED BY THE ENGINEER AND AS SHOWN IN IDOT STANDARD 28000

SECTION 280. TEMPORARY EROSION CONTROL, OF THE STANDARD SPECIFICATIONS ADDITIONALLY SUPPLEMENTS THIS PLAN.

1. THE PROJECT IS LOCATED NORTHEAST OF THE INTERSECTION OF BUTTERFIELD ROAD (ROUTE 56) AND ROUTE 53 IN DUPAGE COUNTY, IL

THE GLEN BRIAR PARK PROJECT SHALL GENERALLY CONSIST OF THE FOLLOWING 1.) TOPSOIL STRIPPING, EARTH EXCAVATION, AND STRUCTURAL FILL PLACEMENT; INSTALLATION OF UNDERDRAIN AND STORM SEWER; INSTALLATION OF SIDEWALK, WALKING PATHS, PARKING AREA, AND CONCRETE PADS INSTALLATION OF SPORT COURTS, GAME AREAS, SLED HILL, AND NATURAL AREAS.

RUCTION ACTIVITIES WHICH WILL DISTURB SOILS FOR MAJOR PORTION OF THE

. SEDIMENT CONTROL SILT FENCING SHALL BE IN PLACE PRIOR TO EARTHWORK ACTIVITIES

2. SITE SHALL BE MASS-GRADED, WITH ALL PROPOSED PAVEMENTS GRADED TO ROUGHLY 1-FOOT (VARIES) BELOW FINAL ELEVATION ON PLANS. UTILITIES SHALL BE CONSTRUCTED. AFTER COMPLETION OF STORM SEWER CONSTRUCTION, SEDIMENT CONTROL FILTER BARRIER AND SEDIMENT CONTROL FLOW-THROUGH (DROP-IN) FILTERS SHALL BE PLACED AT EACH OPEN-GRATE STRUCTURE. CONCRETE CURB & GUTTER, BITUMINOUS AND CONCRETE PAVEMENT, AND BITUMINOUS TRAILS SHALL BE CONSTRUCTED. SITE SHALL BE TEMPORARILY STABILIZED IMMEDIATELY FOLLOWING MASS GRADING COMPLETION.

THE SITE SHALL BE SEEDED AND STABILIZED WITH BIODEGRADABLE EROSION CONTROL MAT (WHERE NOTED) UPON COMPLETION OF THE 8. TEMPORARY EROSION CONTROL MEASURES WILL BE REMOVED FOLLOWING FINAL STABILIZATION

THE TOTAL AREA OF THE CONSTRUCTION SITE IS ESTIMATED TO BE 2.97 ACRES BY WHICH 2.14 ACRES WILL BE DISTURBED BY EXCAVATION, GRADING

THER REPORTS, STUDIES AND PLANS, WHICH AID IN THE DEVELOPMENT OF THE STORM WATER POLLUTION PREVENTION PLAN AS REFERENCED

INFORMATION OF THE SOILS AND TERRAIN WITHIN THE SITE WAS OBTAINED FROM TOPOGRAPHIC SURVEYS AND WERE USED FOR THE DEVELOPMENT OF THE PROPOSED TEMPORARY EROSION AND SEDIMENT CONTROL SYSTEMS PROJECT PLAN DOCUMENTS. SPECIFICATIONS AND SPECIAL PROVISIONS, AND PLAN DRAWINGS INDICATING DRAINAGE PATTERNS AND APPROXIMATE SLOPES ANTICIPATED AFTER GRADING ACTIVITIES WERE UTILIZED FOR THE PROPOSED PLACEMENT OF THE TEMPORARY EROSIO

DRAINAGE TRIBUTARIES AND SENSITIVE AREAS RECEIVING RUNOFF FROM THIS CONSTRUCTION SITE

DATE

1. THE EXISTING SITE DRAINS GENERALLY FROM NORTHWEST TO SOUTHEAST TO THE EXISTING SWALE ALONG BUTTERFIELD ROAD (ROUTE 56). THERE ARE NO KNOWN SENSITIVE AREAS IMMEDIATELY DOWNSTREAM OF THE PROJECT AREA AND NO KNOWN OFFSITE AREAS TRIBUTARY TO THIS SITE.

THIS PLAN HAS BEEN PREPARED TO COMPLY WITH THE PROVISIONS OF THE NPDES PERMIT NUMBER ILR10 ISSUED BY THE ILLINOIS ENVIRONMENTAL PROTECTION AGENCY FOR STORM WATER DISCHARGES FROM CONSTRUCTION SITE ACTIVITIES.

I CERTIFY UNDER PENALTY OF LAW THAT THIS DOCUMENT AND ALL ATTACHMENTS WERE PREPARED UNDER MY DIRECTION OR SUPERVISION IN ACCORDANCE WITH A SYSTEM DESIGNED TO ASSURE THAT QUALIFIED PERSONNEL PROPERLY GATHERED AND EVALUATED THE INFORMATION SUBMITTED. BASED ON MY INQUIRY OF THE PERSON OR PERSONS WHO MANAGE THE SYSTEM, OR THOSE PERSONS DIRECTLY RESPONSIBLE FOR GATHERING THE INFORMATION. THE INFORMATION SUBMITTED IS TO THE BEST OF MY KNOWLEDGE AND BELIEF, TRUE, ACCURATE AND COMPLETE. I AM AWARE THAT THERE ARE SIGNIFICANT PENALTIES FOR SUBMITTING FALSE INFORMATION, INCLUDING THE POSSIBILITY OF FINE AND

FICATION_
HAT I UNDERSTAND THE
STEM (NPDES) PERMIT
IWATER DISCHARGES CONSTRUCTION SITE

DATE

OWNER'S	CERTIFICATION

"I CERTIFY UNDER PENALTY OF LAW THAT THIS DOCUMENT AND ALL ATTACHMENTS WERE PREPARED UNDER MY DIRECTION OR SUPERVISION IN ACCORDANCE WITH A SYSTEM DESIGNED TO ASSURE THAT QUALIFIED PERSONNEL PROPERLY GATHERED AND EVALUATED THE INFORMATION SUBMITTED. BA INQUIRY OF THE PERSON OR PERSONS WHO MANAG SYSTEM, OR THOSE PERSONS DIRECTLY RESPONSIBI GATHERING THE INFORMATION, THE INFORMATION SU TO THE BEST OF MY KNOWLEDGE AND BELIEF, TRUE, ACCURATE AND COMPLETE. I AM AWARE THERE ARE SIGNIFICANT PENALTIES FOR SUBMITTING FALSE INFORMATION, INCLUDING THE POSSIBILITY OF FINE AND IMPRISONMENT FOR KNOWING VIOLATIONS."

<u>OWNER</u>

SIGNATURE DATE TITLE

COMPANY



21W730 Butterfield Rd Lombard, Illinois 60148 Phone: 630-858-2229

PROJECT

Glenbriar OSLAD Phase III Development

21W730 Butterfield Rd Lombard, Illinois 60148





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ENGINEER Engineering Resource Associates 3S701 West Avenue Suite 150 Warrenville, IL 60555 Phone: 630-393-3060

SURVEYOR Zeitler Consulting, Inc. 1130 Randville, Unit 1B Palatine, Illinois 60074 Phone: 224-220-6030


SHEET TITLE

Stormwater Pollution Preventi

SHEET NUMBER

RAW /	REVISION	
_D/JF	Issue for Permit	17JUL2023

ASED ON MY	
GE THE	
LE FOR	
UBMITTED IS,	

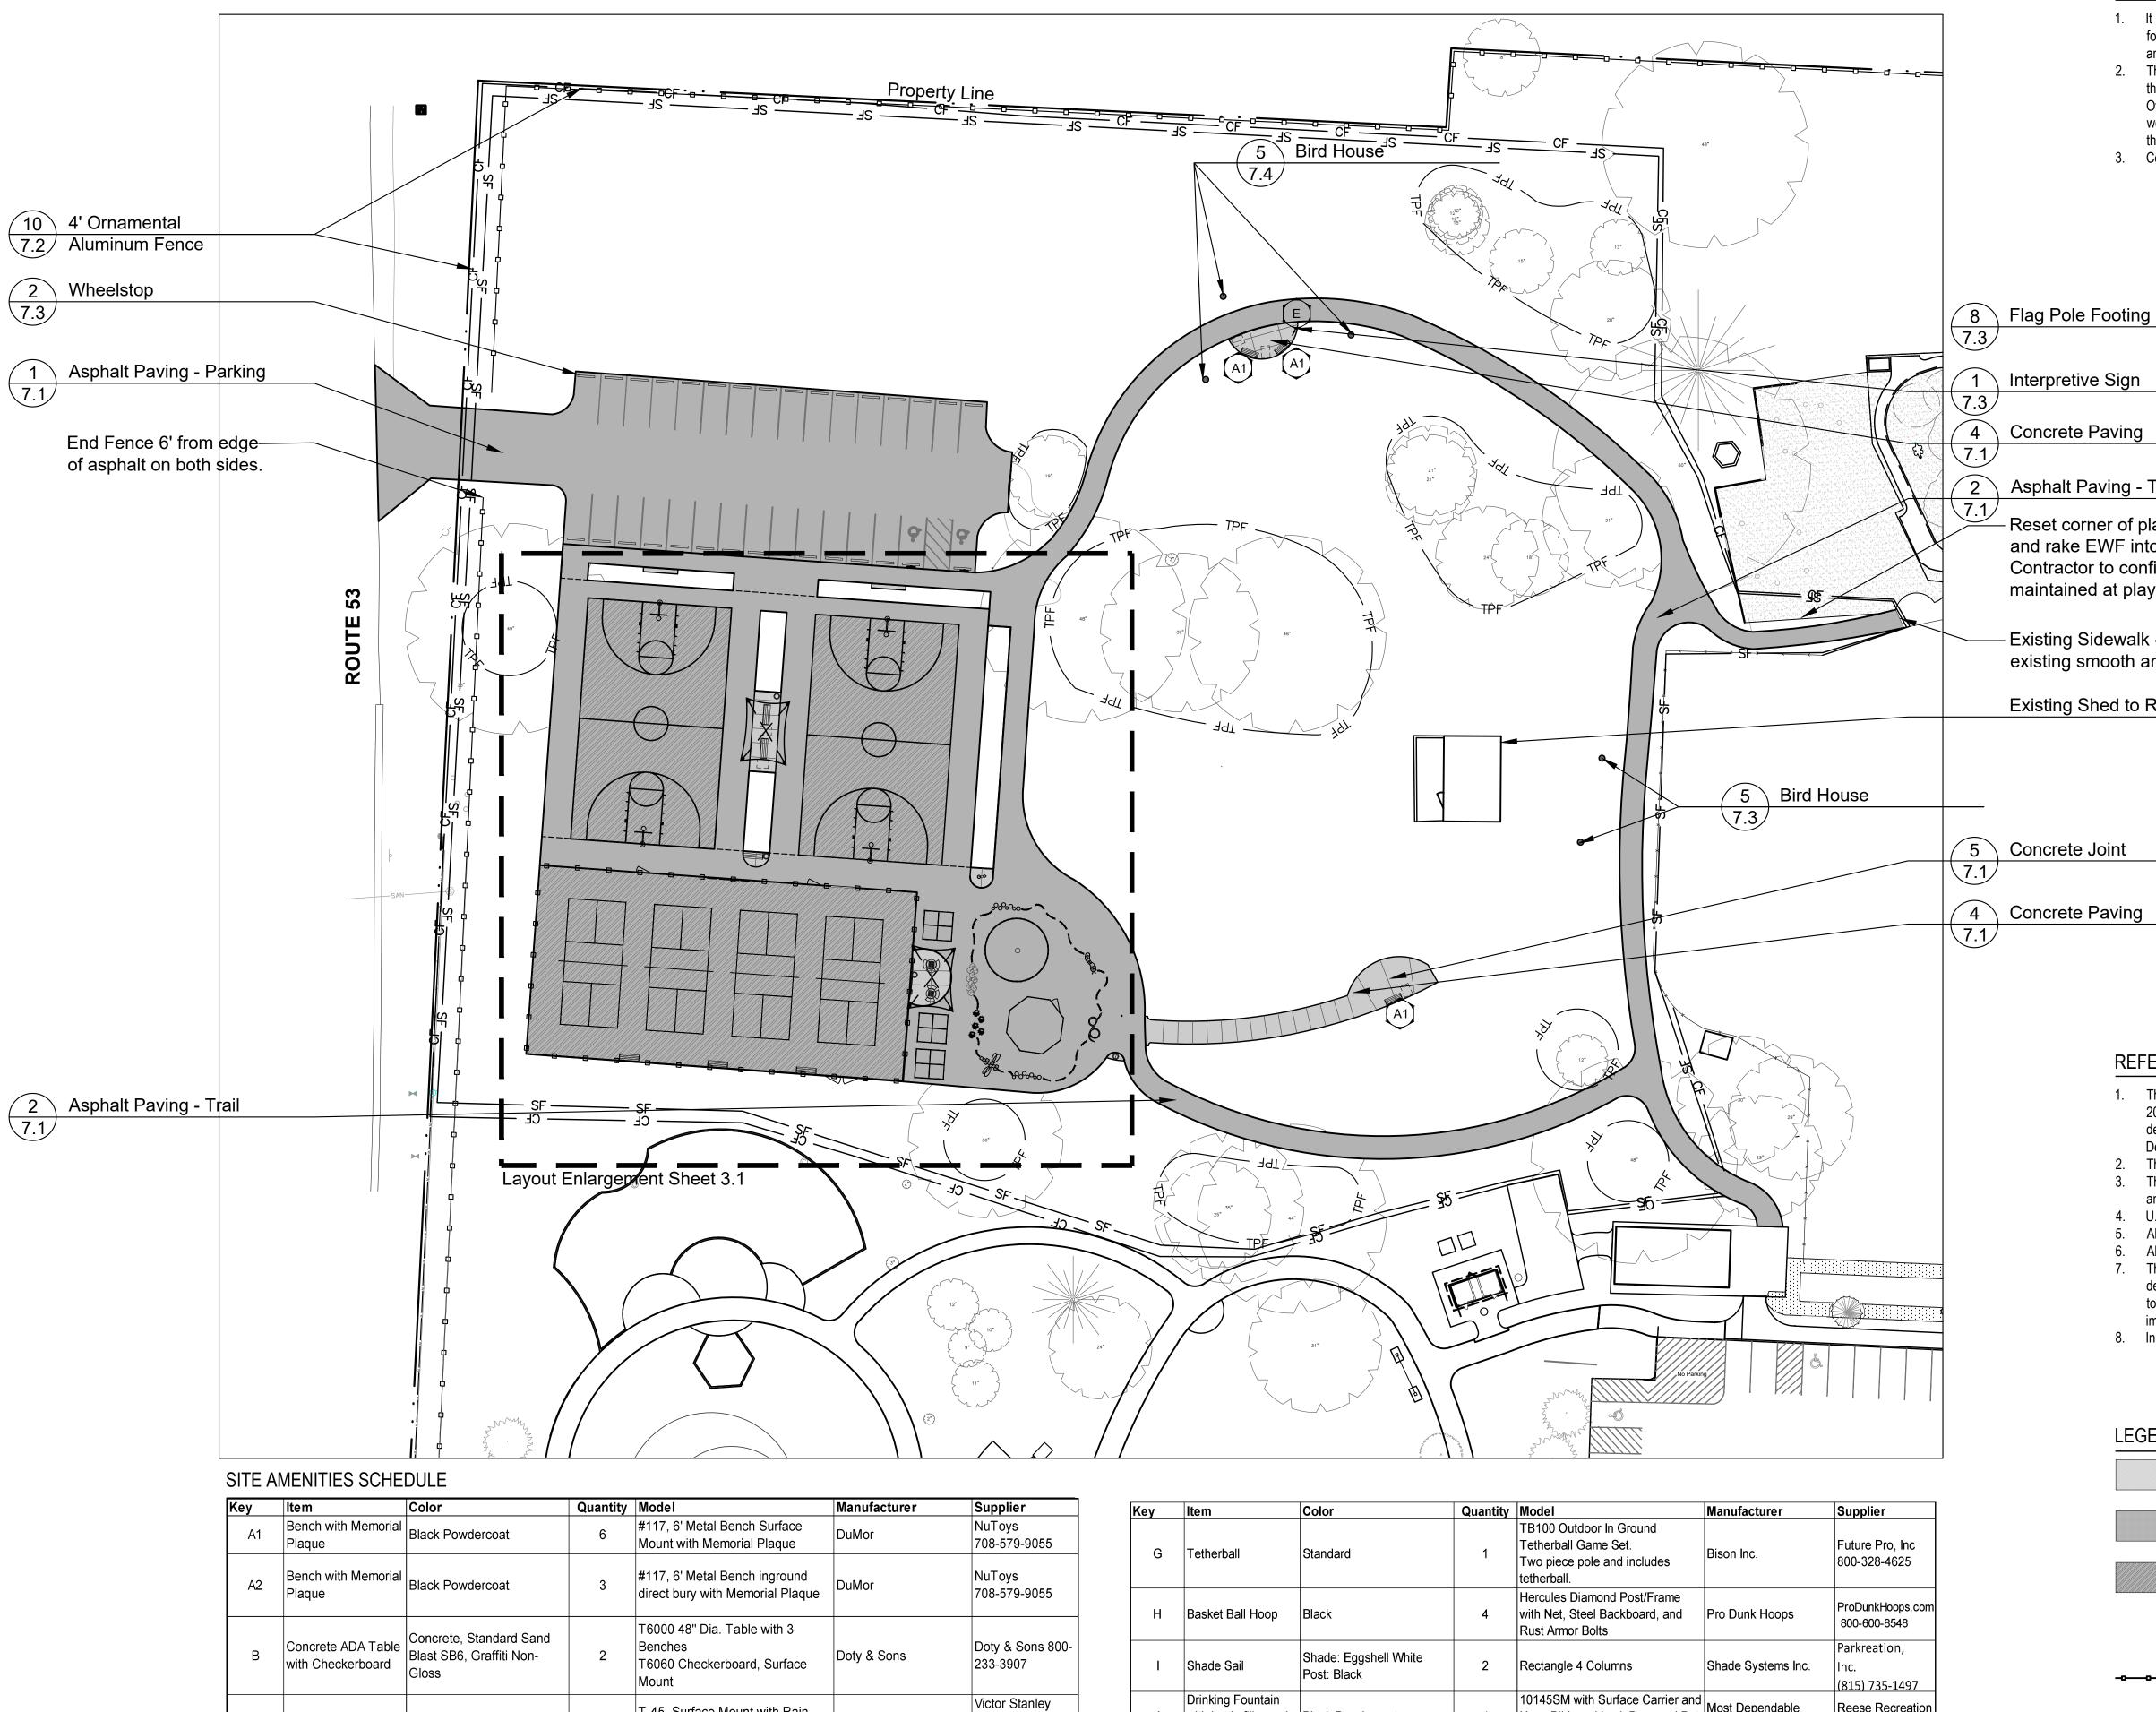

D	with Checkerboard	Gloss	L	T6060 Checkerboard, Surface Mount		
С	Litter Receptacle	Black Powdercoat	4	T-45, Surface Mount with Rain Bonnet Lid	Victor Stanley	
D	Pickleball Ground Sleeve, Net, Ground Anchor, and Tie Down Strap	Steel Post: Black Powdercoat Net: N/A	4 SETS	#63070, 63071, Premier RD-36, 3" OD round #20045, TN-45, In Ground	Douglas Sports	
E	Interpretive Signage	Customized Sign Panels Black Powdercoat - posts	1	Custom, In Ground mount, 24 H X 24 W : 1/2" Exterior Panel Single Sided, single post pedestal, Graphics to come	iZone	
F	Gaga Ball	Composite Lumber: Brown Wall Top and Brackets: Red	1	Octagon 30H, 20' Diameter Wall-to- Wall, Surface Mount	Coach Cliff's GaGa Ball Pits	

S	upplier	K	ley	ltem	Color	Quantity	Model	Manufacturer	Supplier
7	uToys 08-579-9055 uToys		G	Tetherball	Standard	1	TB100 Outdoor In Ground	Bison Inc.	Future Pro, Inc 800-328-4625
70	08-579-9055		Н	Basket Ball Hoop	Black	4	Hercules Diamond Post/Frame with Net, Steel Backboard, and Rust Armor Bolts	Pro Dunk Hoops	ProDunkHoops.com 800-600-8548
	oty & Sons 800- 33-3907		I	Shade Sail	Shade: Eggshell White Post: Black	2	Rectangle 4 Columns	Shade Systems Inc.	Parkreation, Inc. (815) 735-1497
30	ictor Stanley 01-855- 300x341		J	Drinking Fountain with bottle filler and dog bowl	Black Powdercoat	1	10145SM with Surface Carrier and Hose Bibb and Lock Door and Pet Fountain	Most Dependable Fountain	Reese Recreation 847-404-6725
NuToys Leisure Products (800) 526-6198		К	Next Up Spinner	Standard	1	Boomer "Next- Up" Tracker Fence Mounted	Boomer Pickleball	Boomer Pickleball 1800-970-0308	
	· ,		L	Pickleball Racket Holder	Standard	4	Boomer HD Paddle Rack Fence Mounted	Boomer Pickleball	Boomer Pickleball 1800-970-0308

iZone 888-464-9663

Coach Cliff's GaGa Ball Pits 877-266-8426

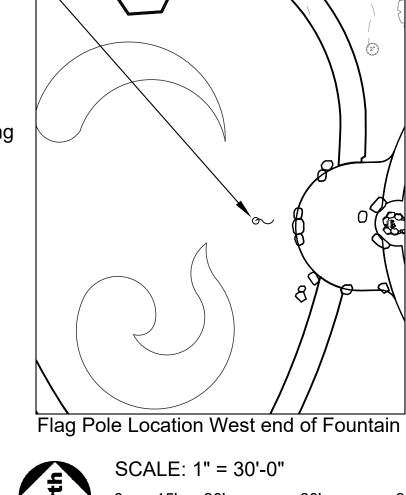
GENERAL NOTES: LAYOUT

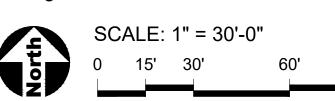
- 1. It is the responsibility of the Contractor to perform layout of all project elements and points for review by Owner prior to construction. (This work is considered incidental to the project and not paid as a separate bid item).
- The contractor shall be responsible for all materials and quantities as required to complete 2 the work in accordance with the plans and specifications. The contractor will notify the Owner's Representative in writing of any discrepancies or changes required to complete the work before any action may be taken. All changes or change orders must be approved by the Owner's Representative and Owner before any changes are executed.
- Contractor shall follow DuPage County permit requirements as part of the project.

Interpretive Sign

Asphalt Paving - Trail

- Reset corner of playground edging and rake EWF into place. Contractor to confirm fall zone is maintained at play equipment
- Existing Sidewalk connect to existing smooth and flush
- Existing Shed to Remain





REFERENCED SPECIFICATIONS AND CODES

- The Standard Specifications for Road and Bridge Construction (SSRBC), adopted April 1, 1. 2016 adopted by the Illinois department of Transportation, and all amendments thereto the design manual, highway standards, and the culvert manual, also prepared by the Illinois Department of Transportation.
- The Americans with Disabilities Act and the Illinois Accessibility Code. 2.
- The Illinois Procedures and Standards for Urban Soil Erosion and Sedimentation Control, and IEPA Standards and Specifications for Soil Erosion and Sedimentation Control.
- 4. U.S. Soil Conservation Service Field Engineering Handbook All codes and ordinances of the Dupage County, and all agencies having jurisdiction.
- All requirements of the Occupational Safety and Health Administration.
- The cited standard specifications, codes and permits, with these construction plans and details, are all to be considered part of the work, incidental items or accessories necessary to complete this work may not be specifically noted but are considered a part of these improvements.
- 8. In case of conflict, the more restrictive provision shall apply.

LEGEND

	Concrete Paving
	Asphalt Paving
	Asphalt Paving - Color Coat
EJ	Concrete Expansion Joints
-000	Ornamental Fence Fence
CF	Construction Fence



SC	ALE:	1" = 30	0'-0"	
0	15'	30'	60'	90'



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SURVEYOR

Zeitler Consulting, Inc. 1130 Randville, Unit 1B Palatine, Illinois 60074 Phone: 224-220-6030

SHEET TITLE Layout Plan

SHEET NUMBER

3.0

DRAW	DRAW / REVISION		
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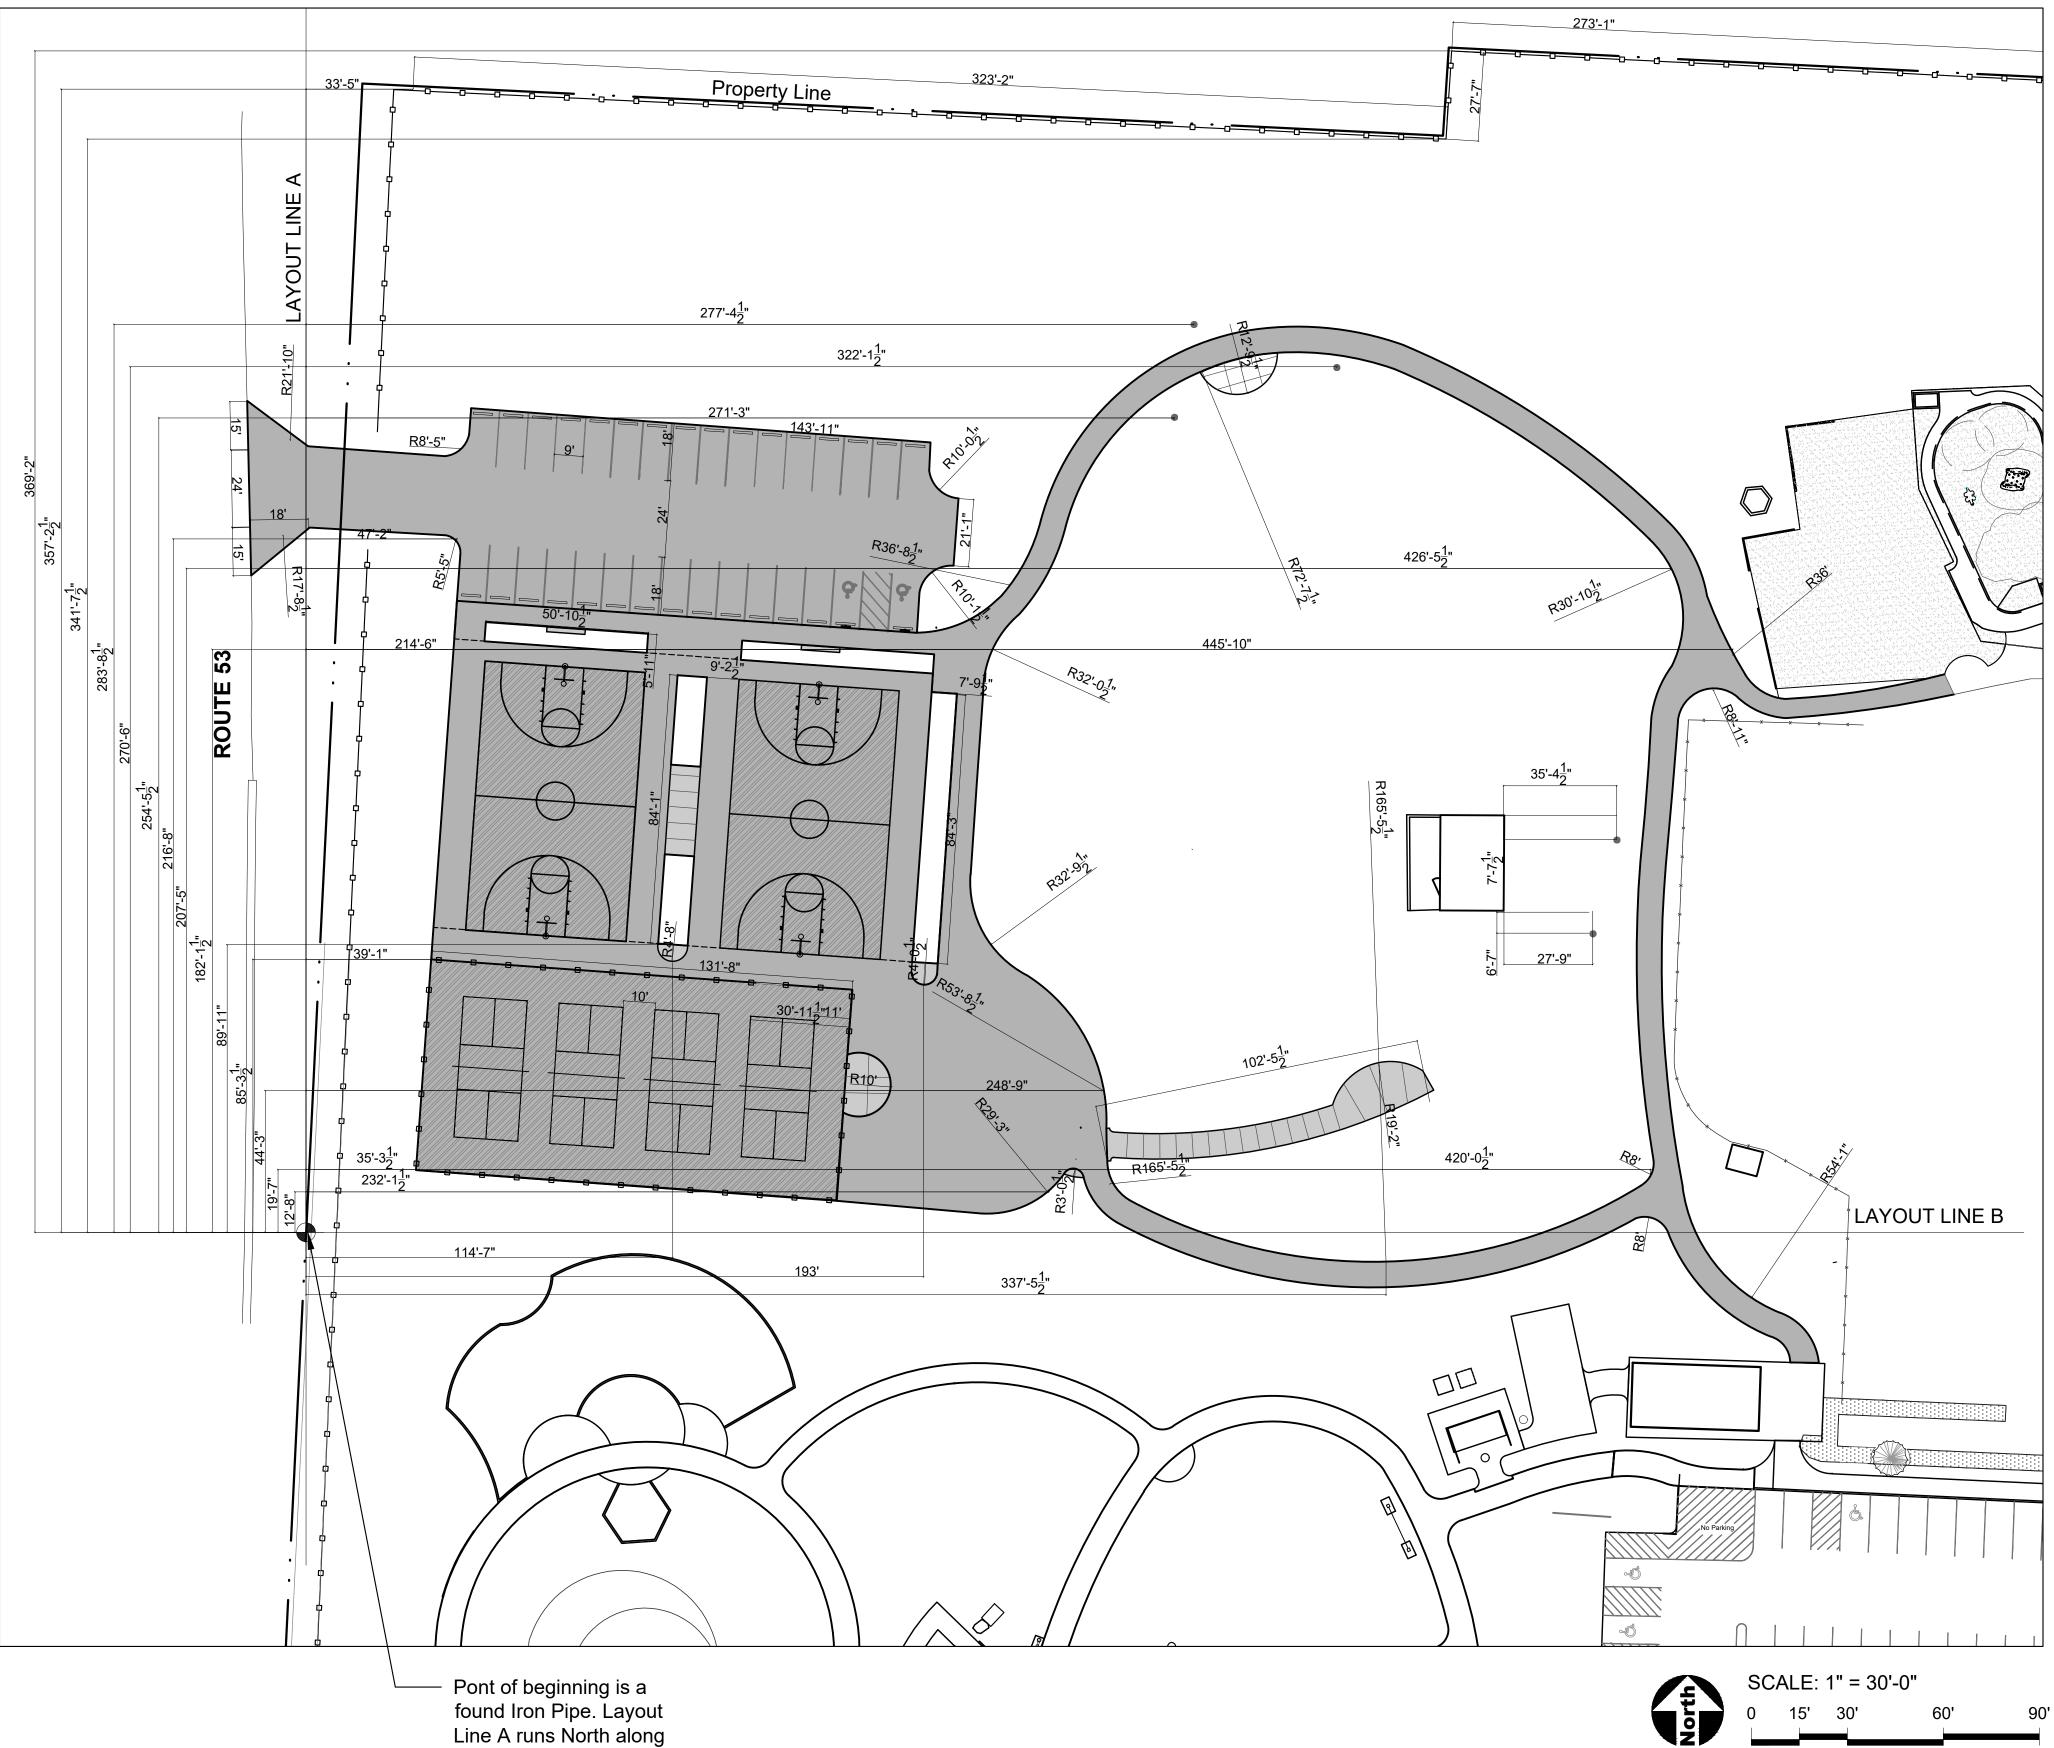
SHEET TITLE

Layout Enlargement -West


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DRAW	DRAW / REVISION		
LD/JF	Issue for Permit	17JUL2023	




found Iron Pipe. Layout Line A runs North along the centerline of the iron pipe to an iron pipe at the North end of the park. Layout Line B is perpendicular to Layout Line A.



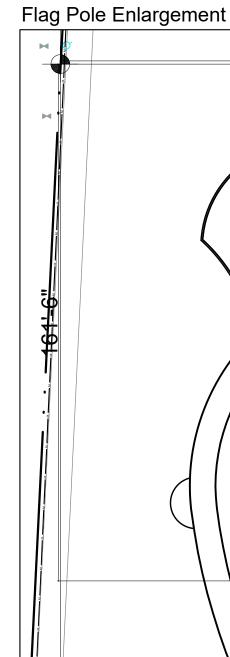GENERAL NOTES: DIMENSION

- Layout of equipment is to center of post. Layout play equipment with safety zones to be staked by the Contractor for review by Owner's Representative prior to play equipment installation.
- Paving radii shall be formed completely and shall smoothly transition into tangents and 3. adjoining lines. Dimensions are to face of curb and edge of pavement unless otherwise specified.
- 4. Dimensions are in feet or degrees. Dimensions are perpendicular & parallel unless otherwise noted.
- 5. See Layout Plan, Sheet 2.0 for additional general notes and referenced specifications and codes.
- Contractor shall perform all construction layout for the project. Contractor will be provided with an electronic file in AutoCAD format to assist with layout. Neither the Owner nor their 6. representative shall be responsible for setting additional layout points.

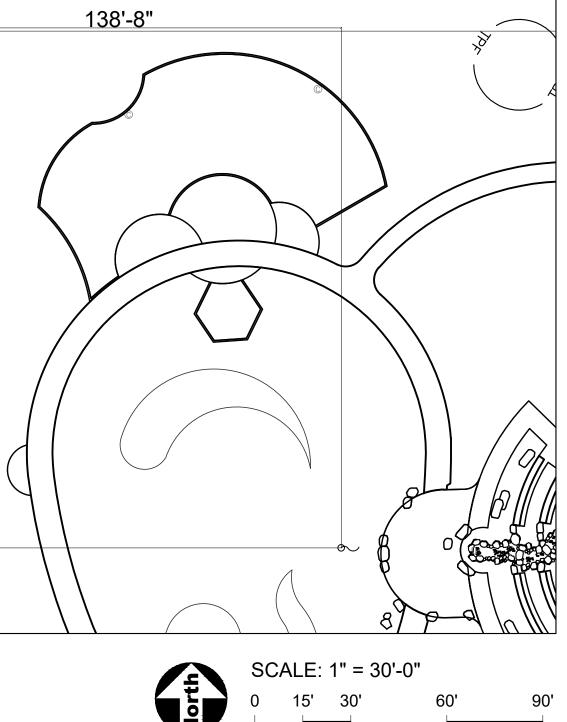

LEGEND

EJ ----- Chainlink Fence

Concrete Paving

Asphalt Paving

Asphalt Paving - Court

Concrete Expansion Joints

Point of Beginning



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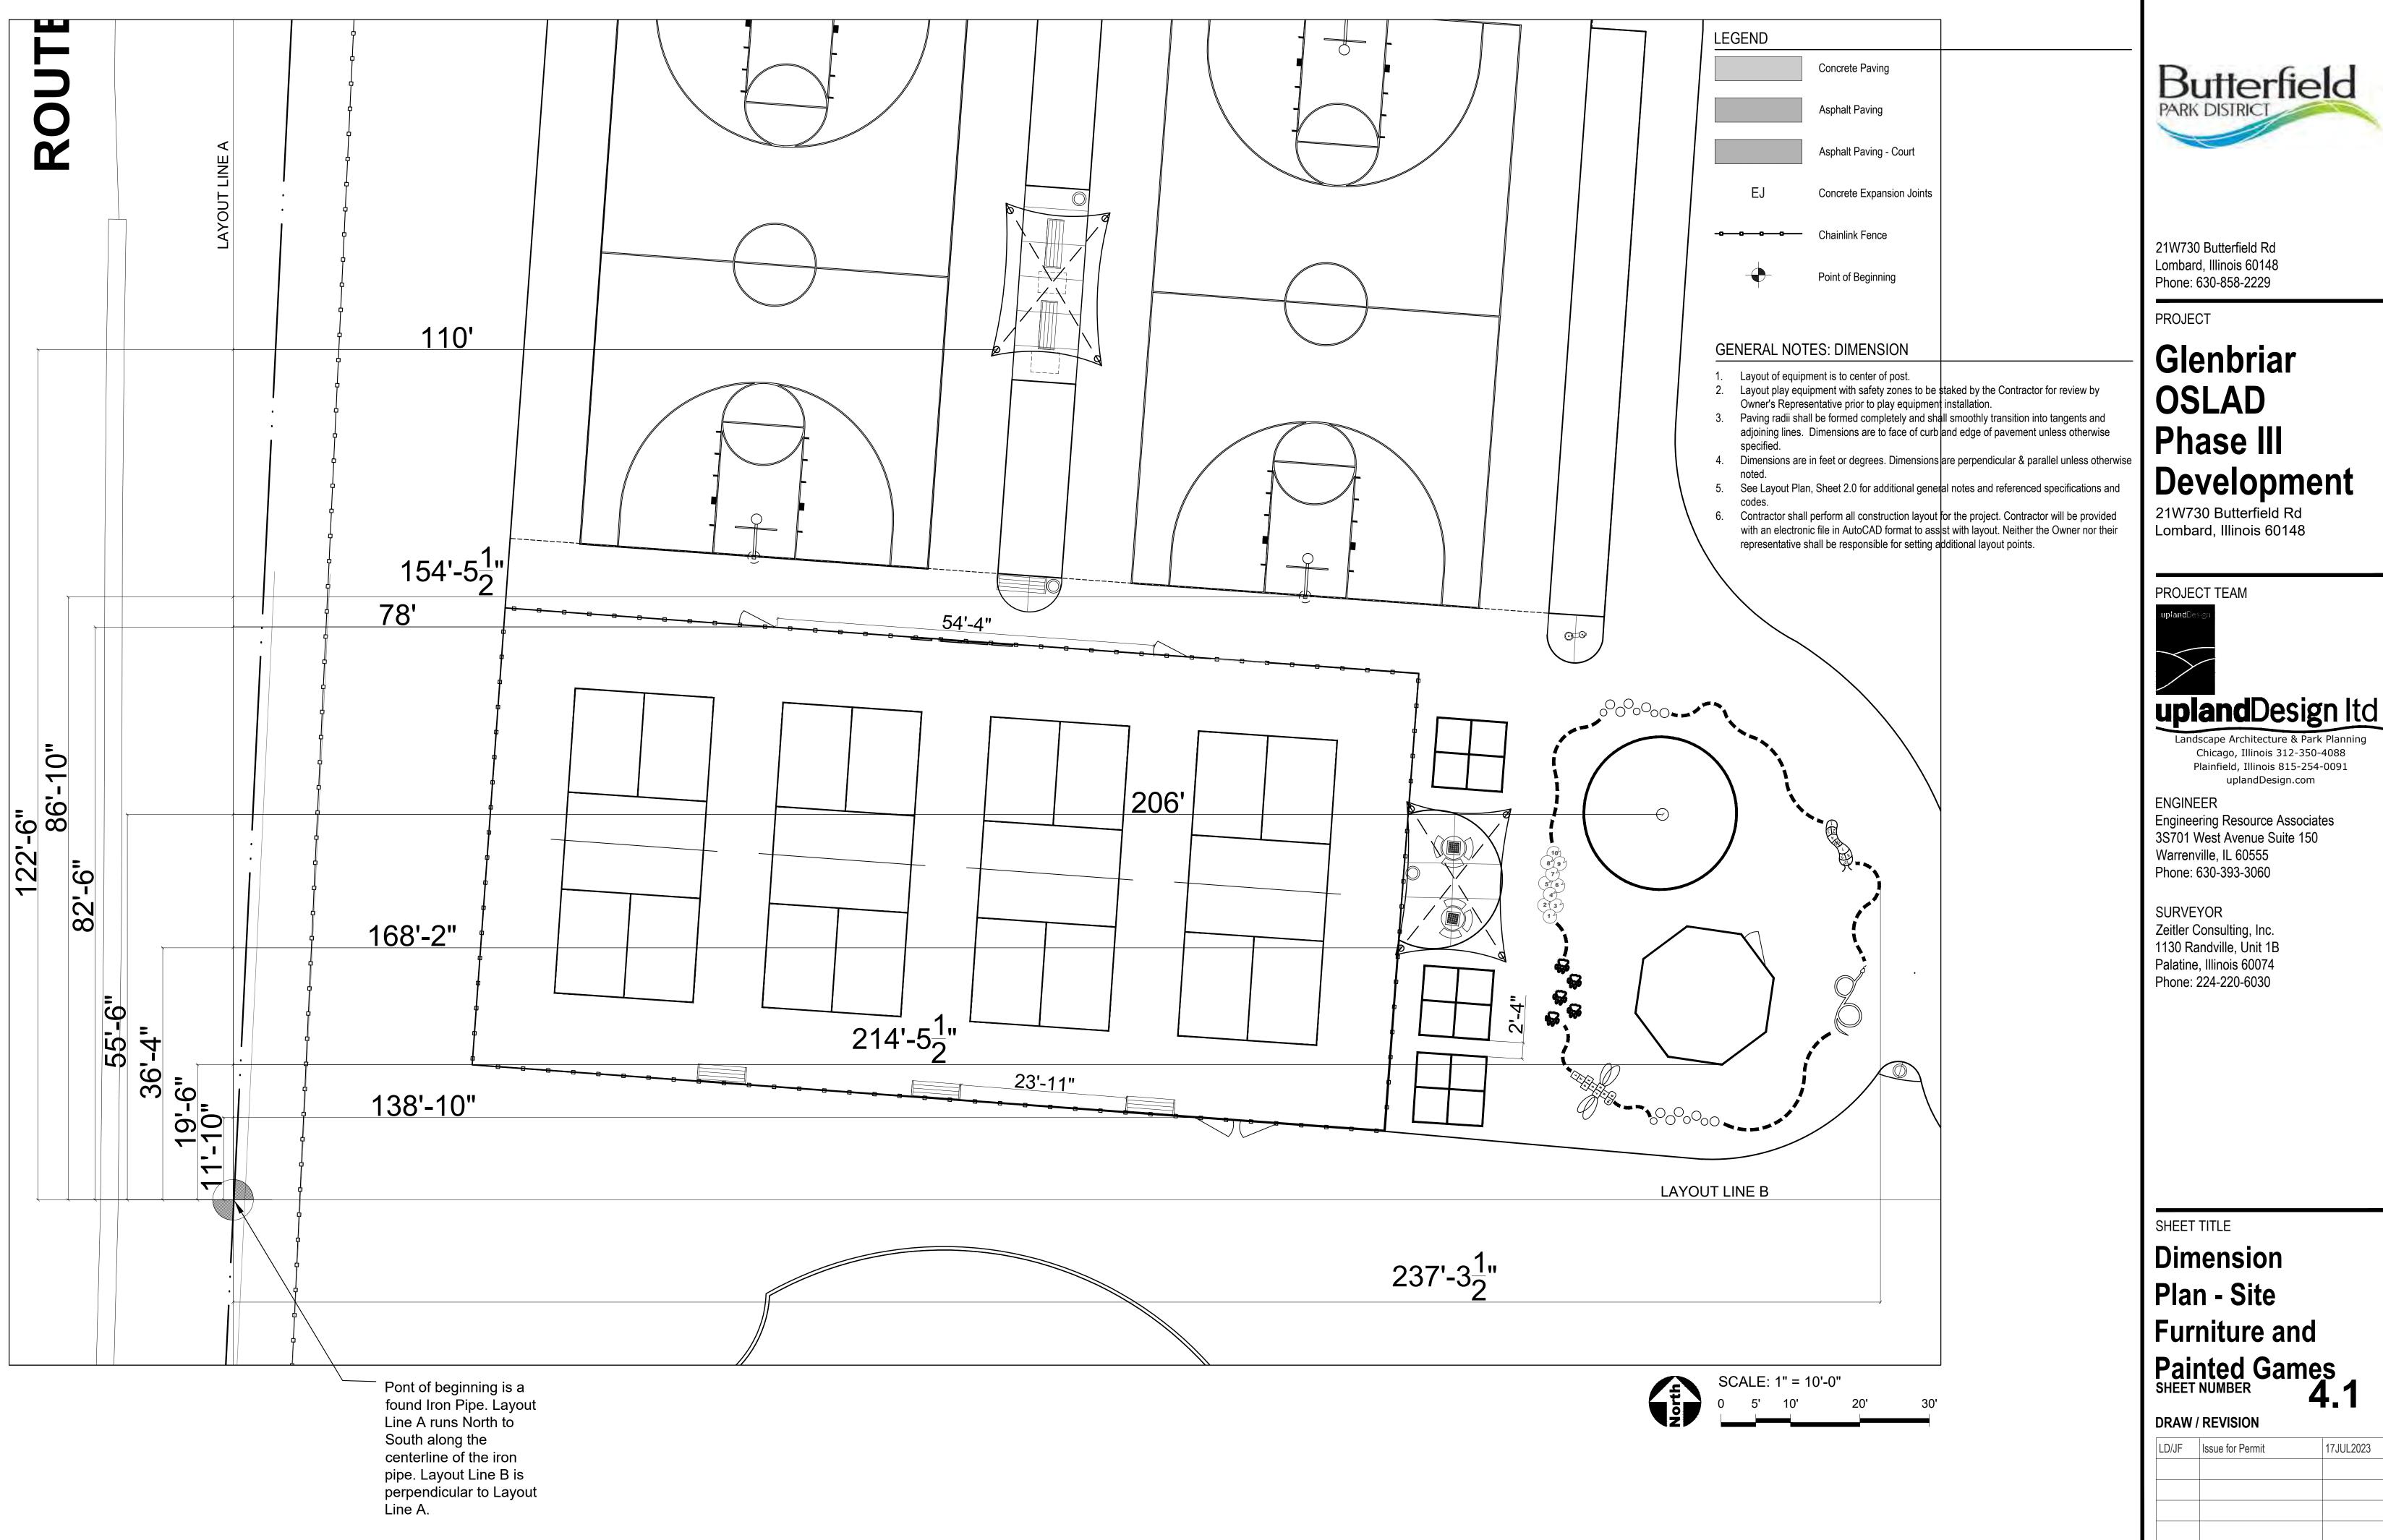
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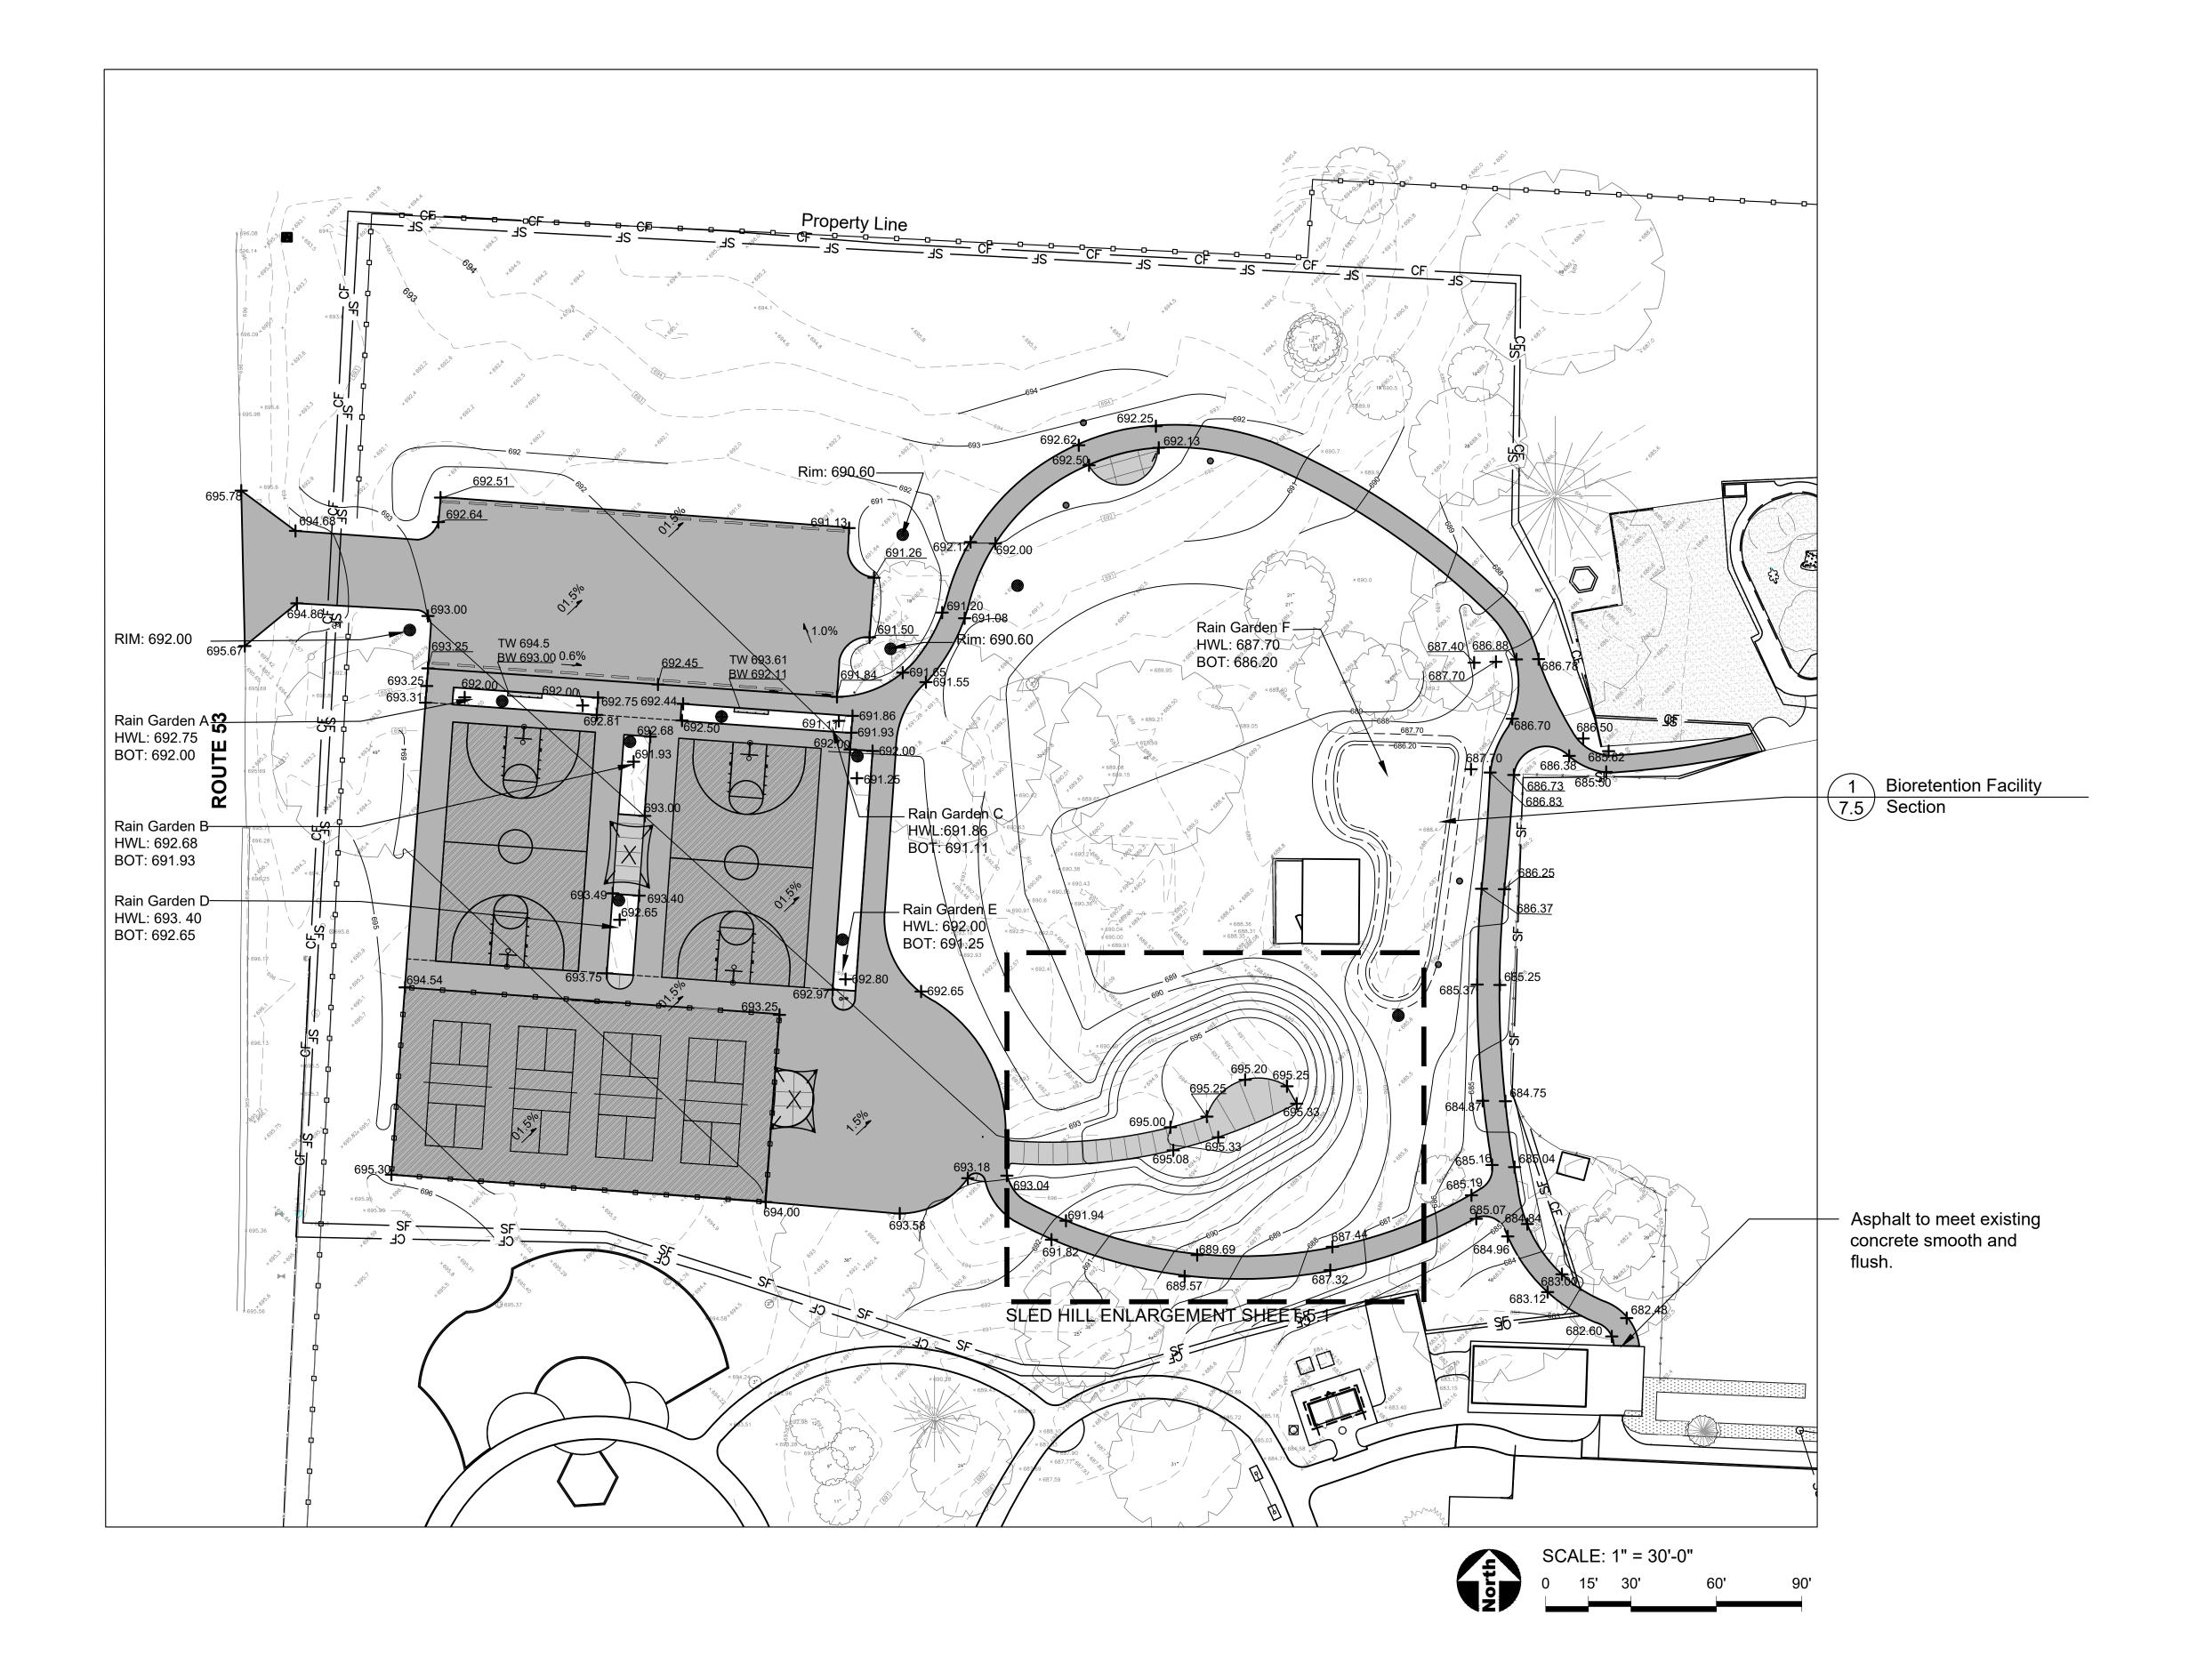
SHEET TITLE



DRAW / REVISION LD/JF Issue for Permit 17JUL2023 Project Number 999-1117



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Project Num	ber 999-1117	•



GENERAL NOTES: GRADING

- Finished surfaces to be smooth and even with no abrupt or awkward changes in grade. Paving to meet adjacent grades flush and smooth.
- 2. Contractor shall restore all areas disturbed as a result of construction.
- All walks, drives and paved areas are to follow ADA per incorporated specifications. Any deviation shall be removed and reinstalled to follow this law.
- 4. All Accessible Route paving shall not exceed 4.5% in any direction. Cross slopes shall be less than 2%. Contractor shall slope all walks and slabs to eliminate ponding. ADA Turning Radius paving shall be less than 2% in all directions.
- 5. This work shall include the excavation, stockpile, and placement of topsoil and suitable excavated material along with removal of all excess topsoil and debris off site and dispose of legally.
- 6. Follow the Illinois Procedures and Standards for Urban Soil Erosion and Sedimentation Control, IEPA Standards and Specifications for Soil Erosion and Sedimentation Control, and U.S. Soil Conservation Service Field Engineering Handbook.
- Dimensions are in feet or degrees. Dimensions are perpendicular & Parallel unless otherwise noted.
- Transitions between paving types (i.e. concrete to asphalt) shall be smooth. Transitions not to exceed 1/8" vertical or horizontal difference.
- 9. Finished Surfaces to be smooth and even with no abrupt or awkward changes in grade. Paving to meet adjacent grades flush and smooth.



 $- \frac{681}{681} = Existing Contour Line}$ $- \frac{681}{681} = Proposed Contour Line}$ $+ \frac{5}{689.66} = Existing Spot Elevation$ $- \frac{2\%}{689.66} = Proposed Spot Elevation$ $- \frac{2\%}{689.66} = Drainage Flow Direction$

INDEX OF ACRONYMS AND ABBREVIATIONS

- HP High Point
- INV Pipe Invert Elevation
- LP Low Point
- ME Match Existing Elevation
- RIM Top of Rim Elevation
- TC Top of Curb
- TP Top of Pavement
- TW Top of Wall



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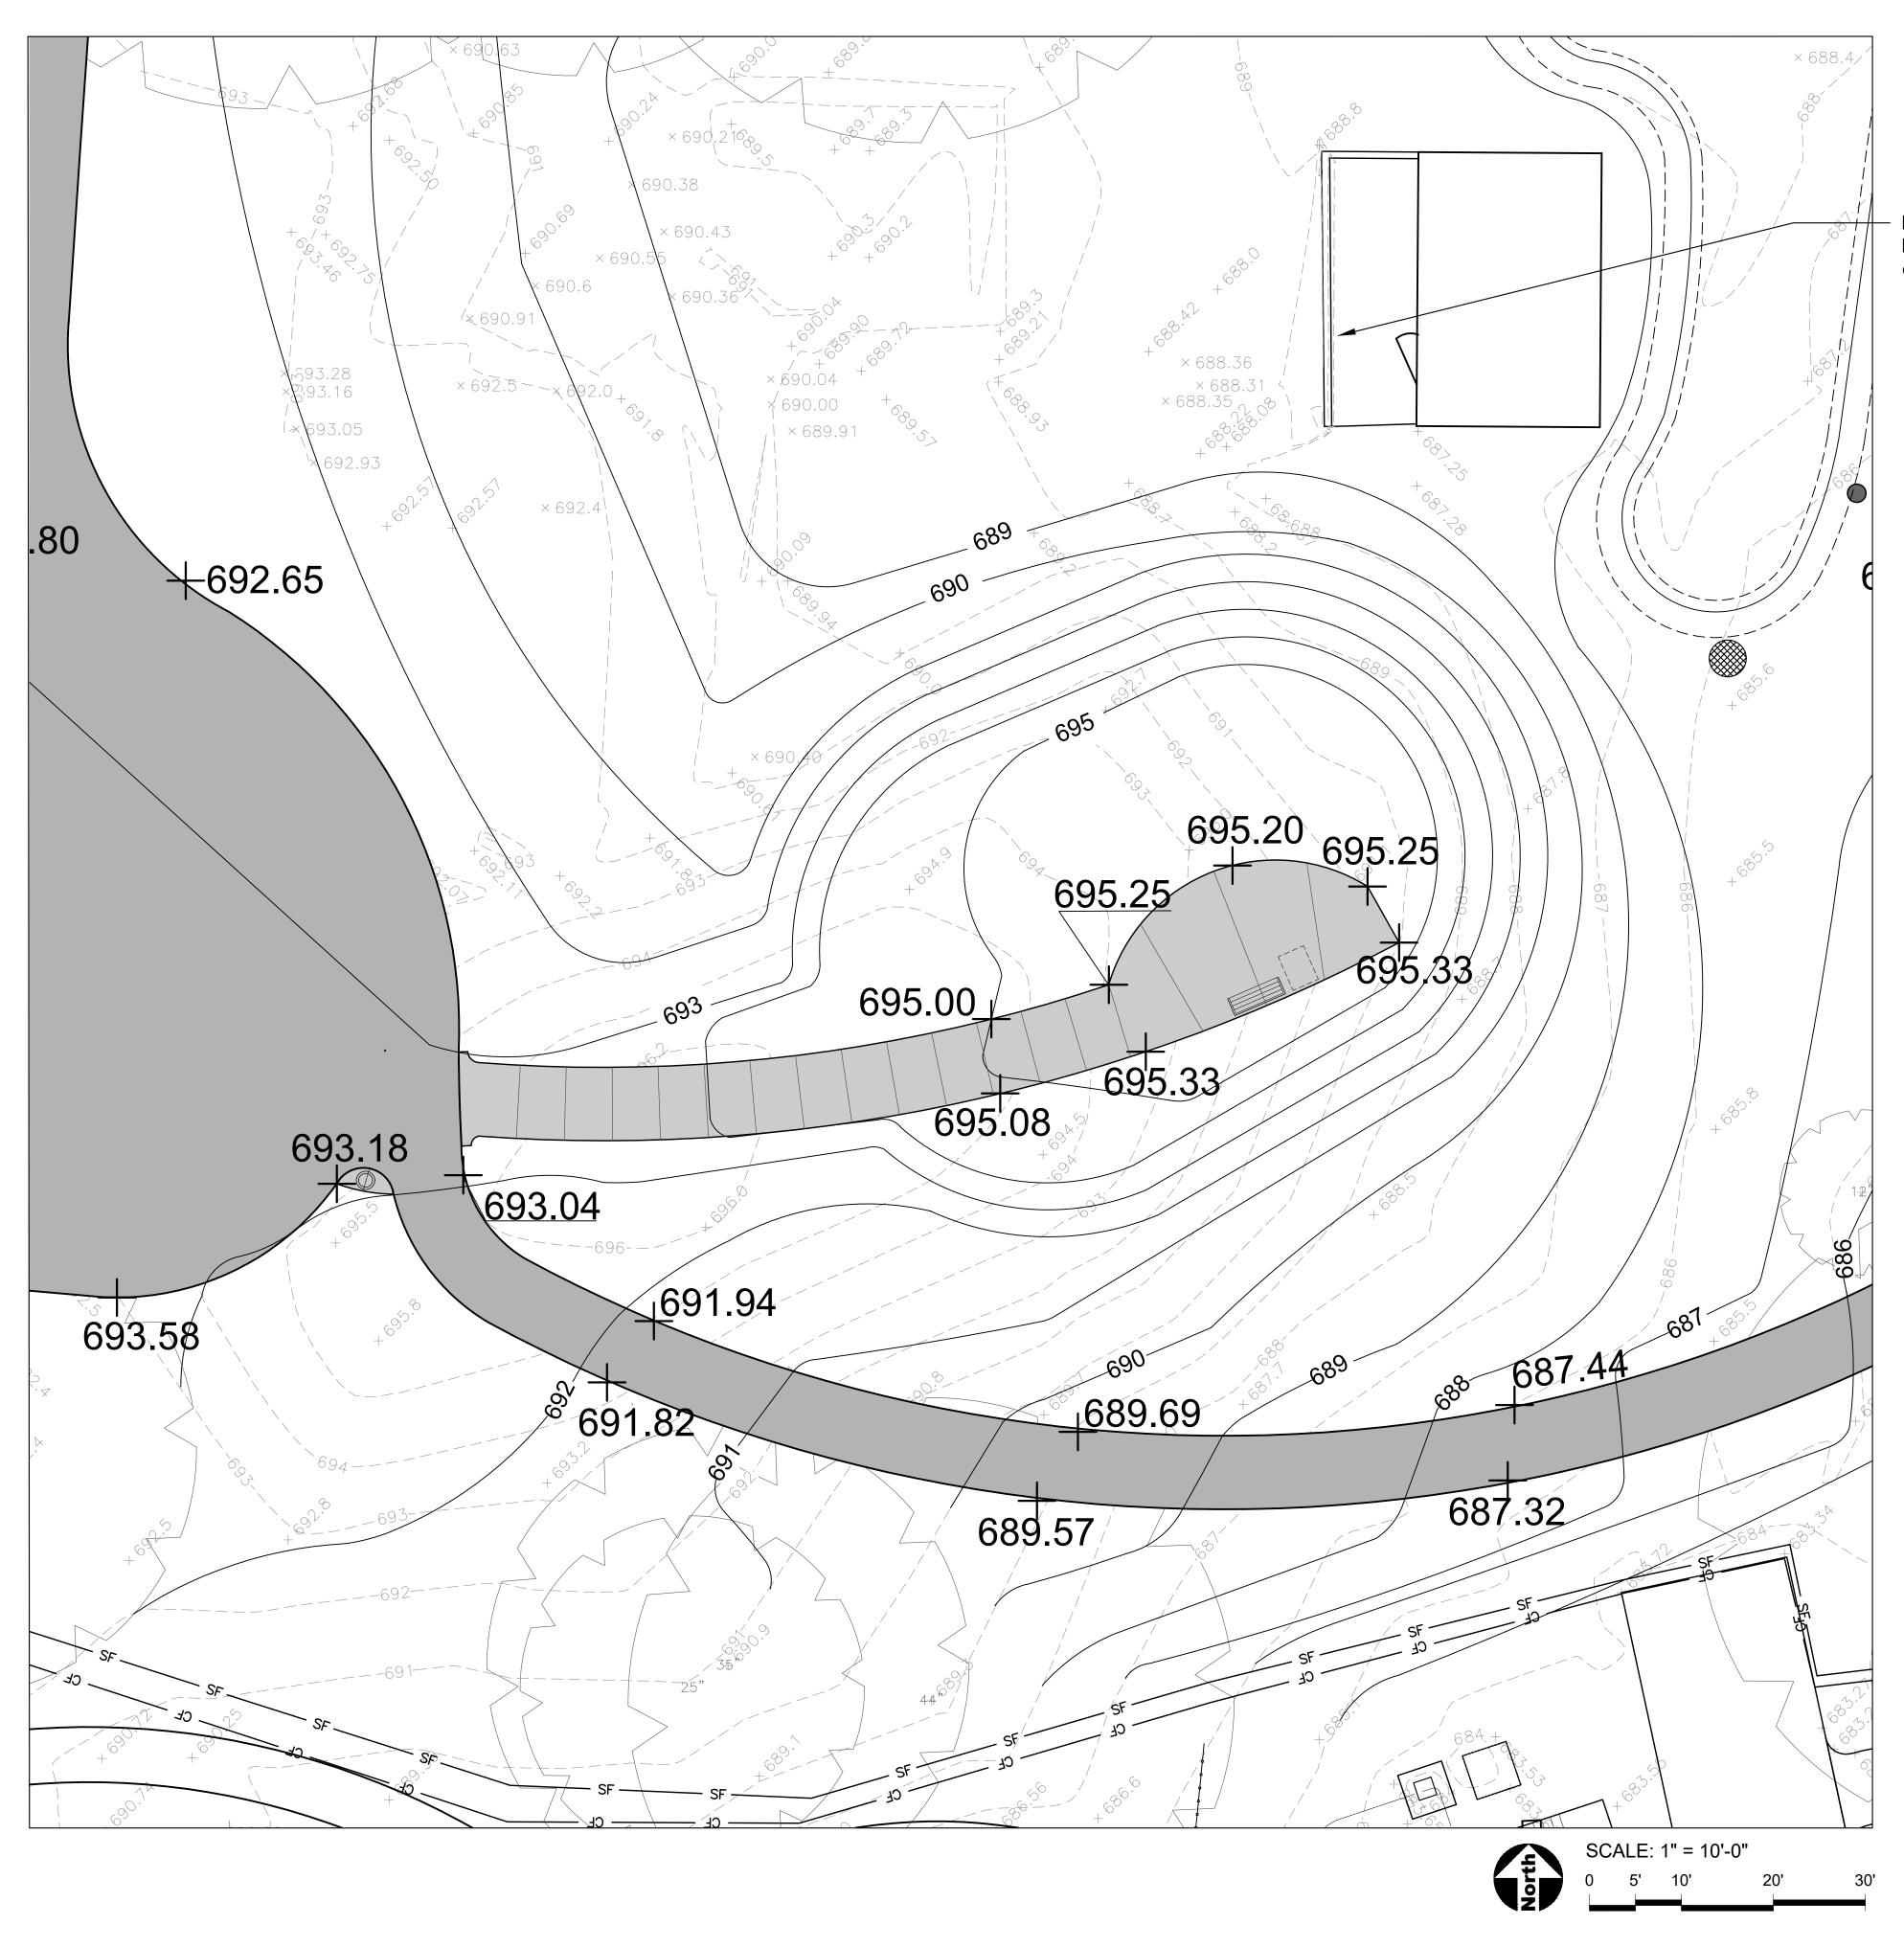
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SHEET TITLE Grading Plan

SHEET NUMBER

5.0

DRAW /	DRAW / REVISION			
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Existing wall to remain. Regrade lawn to meet existing. 1. SEE SHEET 5.0

LEGEND

681Existing Contour Line681Proposed Contour Line+ 5Existing Spot Elevation+ 689.66Proposed Spot Elevation2%Drainage Flow Direction- CLConstruction Limits / Construction Fence

INDEX OF ACRONYMS AND ABBREVIATIONS

HP - High Point

INV - Pipe Invert Elevation

LP - Low Point

ME - Match Existing Elevation

RIM - Top of Rim Elevation

TC - Top of Curb

TP - Top of Pavement

TW - Top of Wall



21W730 Butterfield Rd Lombard, Illinois 60148 Phone: 630-858-2229

PROJECT

Glenbriar OSLAD Phase III Development

21W730 Butterfield Rd Lombard, Illinois 60148

PROJECT TEAM



Landscape Architecture & Park Planning Chicago, Illinois 312-350-4088 Plainfield, Illinois 815-254-0091 uplandDesign.com


ENGINEER Engineering Resource Associates 3S701 West Avenue Suite 150 Warrenville, IL 60555 Phone: 630-393-3060

SURVEYOR Zeitler Consulting, Inc. 1130 Randville, Unit 1B Palatine, Illinois 60074 Phone: 224-220-6030

SHEET TITLE



DRAW / REVISION			
LD/JF	Issue for Permit	17JUL2023	

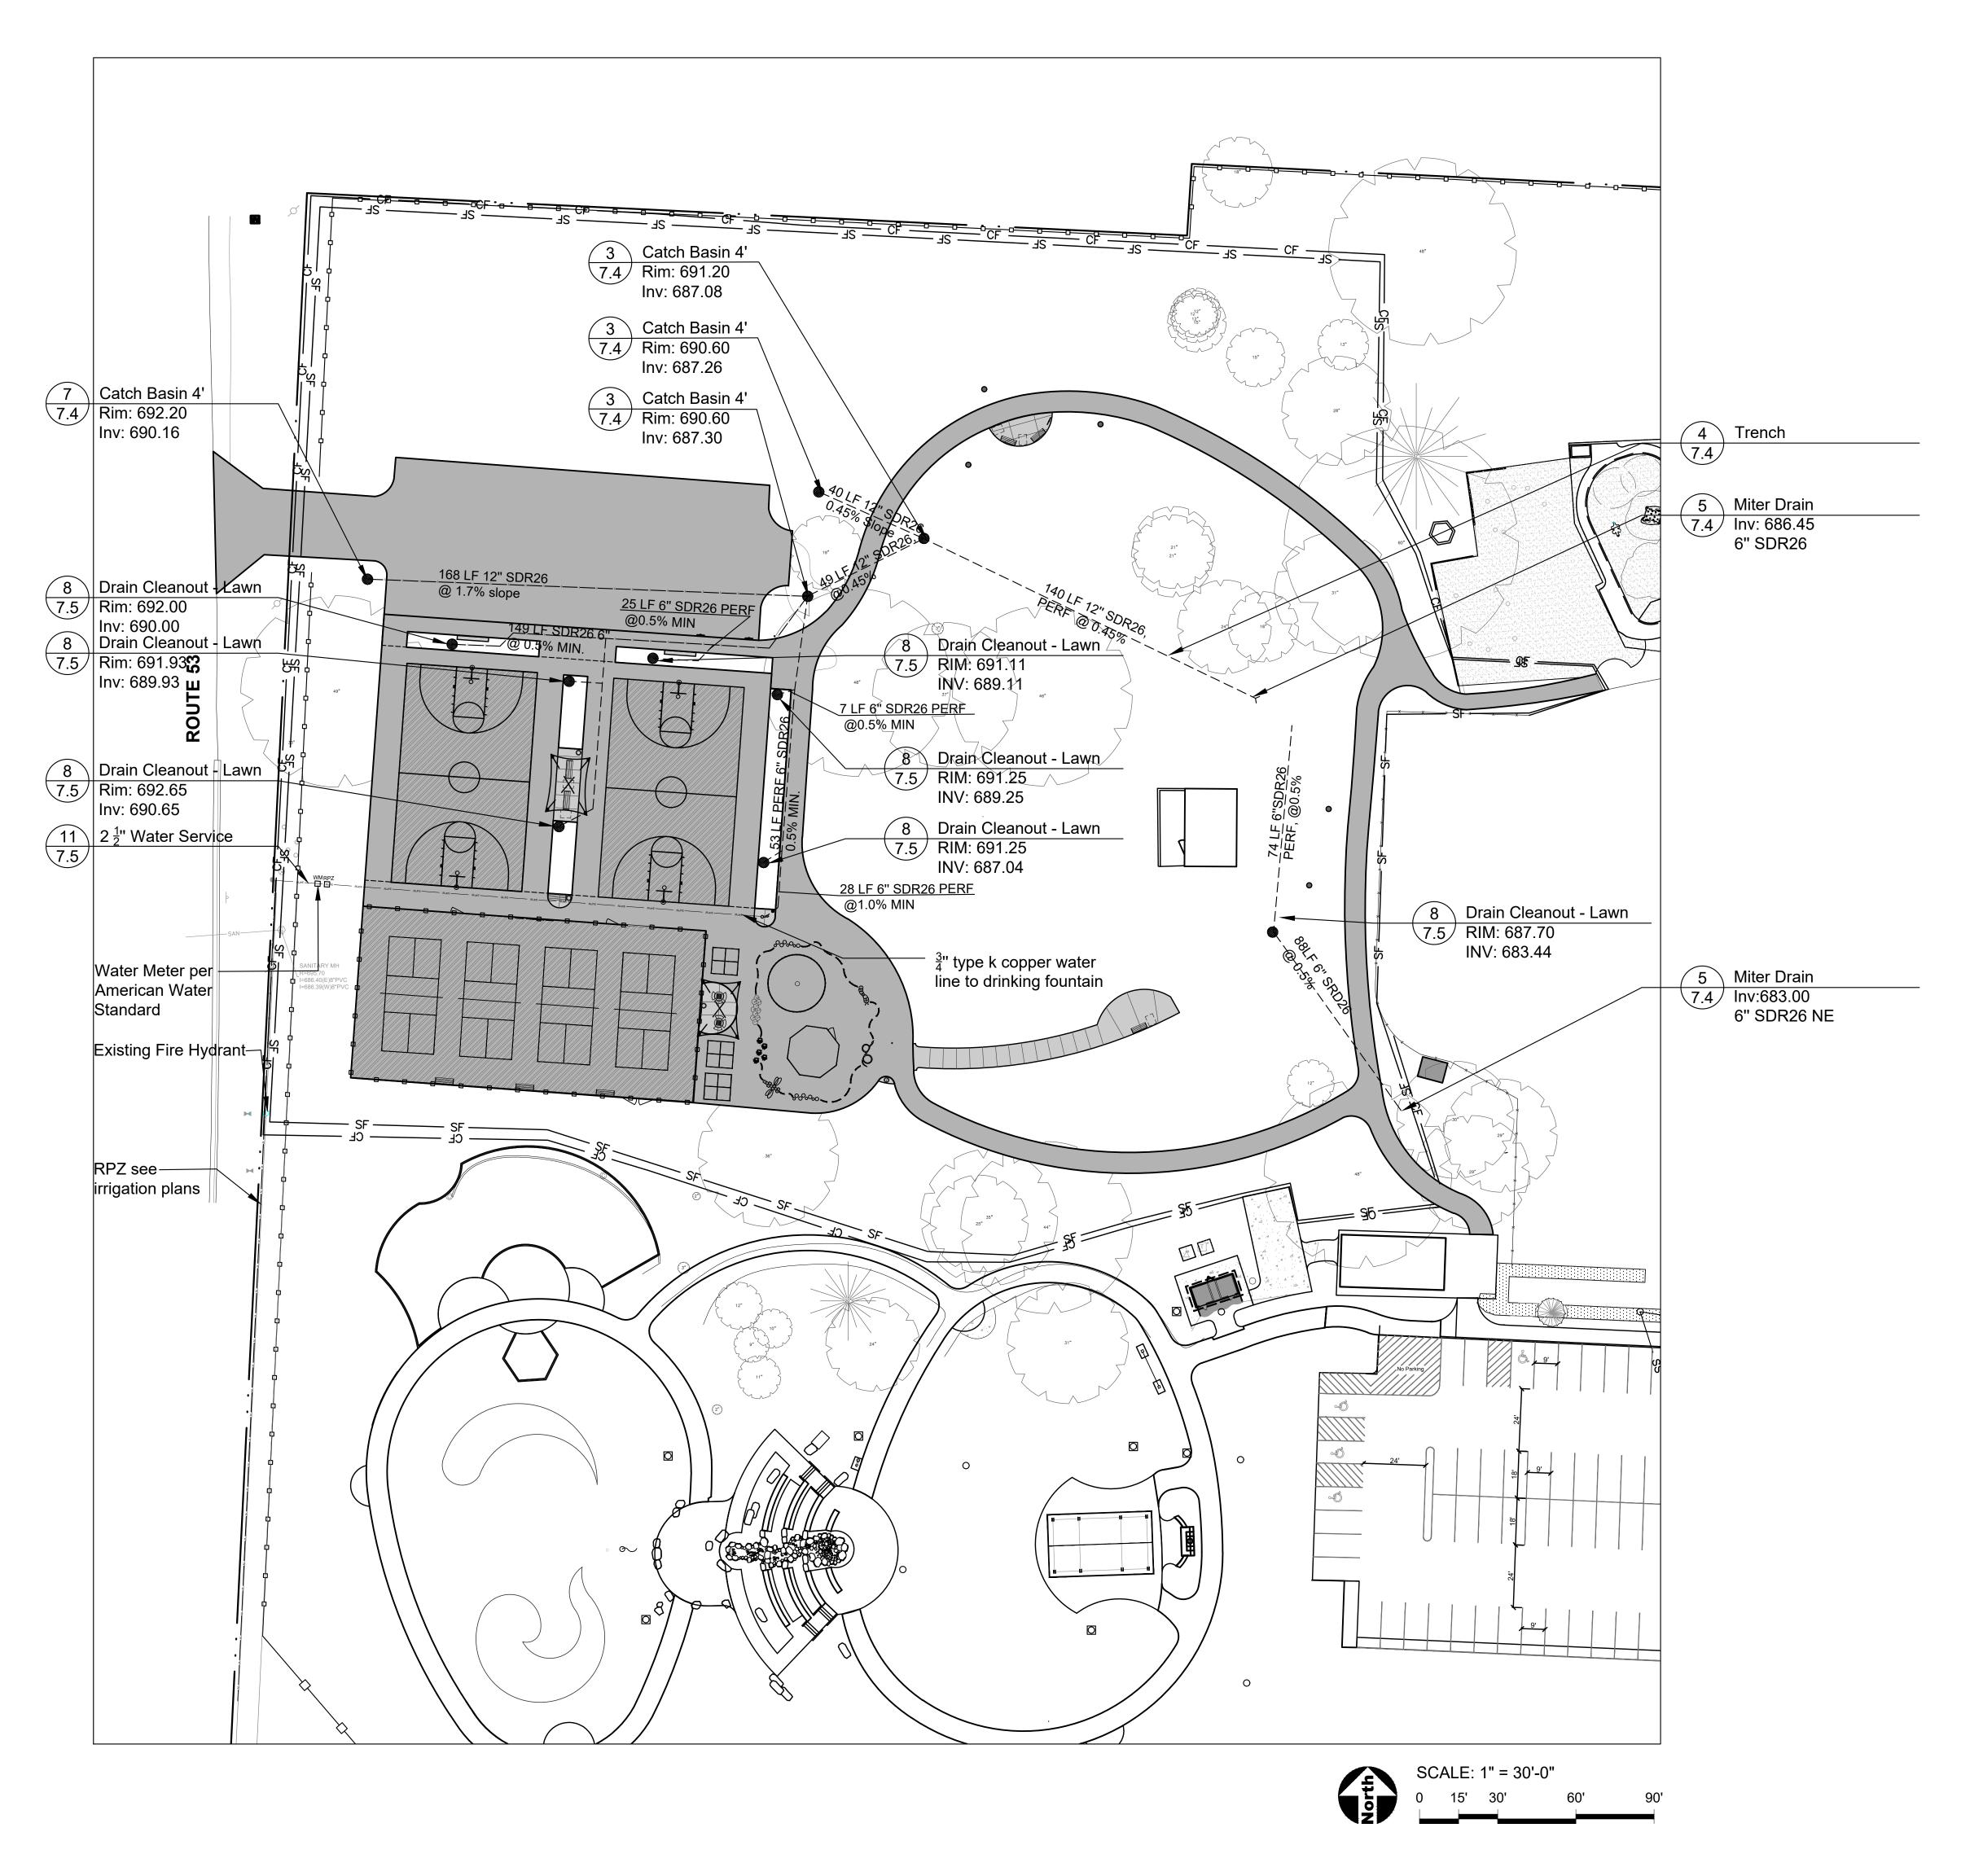

GENERAL NOTES: UTILITY PLAN

- Water system construction shall, in all respects, be in accordance with the regulations of the environmental protection agency of the state of Illinois, and all DuPage County ordinances.
 All domestic water services shall be constructed of type K copper pipe (ASTM B-88), having
- a minimum internal diameter of 1" (unless otherwise noted). 3. Horizontal separation - water and sewers: 3.1. Watermains and services shall be located at least ten (10) feet horizontally from any existing or proposed drain, storm sewer, sanitary sewer, combined sewer or sewer service connection. 3.2. Watermains or services may be located closer than ten (10) feet to a sewer line when: 3.2.1. Local conditions prevent a lateral separation of ten feet; and 3.2.2. The watermain or service invert is at least 18 inches above the crown of the sewer; and The watermain or service is either in a separate trench or in the same trench on 3.2.3. an undisturbed earth shelf located to one side of the sewer. 4. Vertical separation - watermains or service and sewers: 4.1. A watermain or service shall be separated from a sewer so that its invert is a minimum of 18 inches above the crown of the drain or sewer whenever watermains or services cross storm sewers, sanitary sewers or sewer service connections. The vertical separation shall be maintained for that portion of the watermain or service located within ten (10) feet horizontally of any sewer or drain crossed. A length of watermain or service pipe shall be centered over the sewer to be crossed with joints equidistant from the sewer or drain. 4.2. The watermain or service or sewer shall be constructed of slip-on or mechanical joint cast or pvc pipe equivalent to watermain standards of construction when:
- 4.2.1. It is impossible to obtain the proper vertical separation as described in (1) above or:
 4.2.2. The watermain or service passes under a sewer or drain.
- 4.2.2. A vertical separation of 18 inches between the invert of the sewer or drain and the crown of the watermain or service shall be maintained where a watermain or service crosses under a sewer. support the sewer or drain lines to prevent settling and breaking the watermain or service, as shown on the plans or approved by the Engineer.
- 4.4. Construction shall extend on each side of the crossing until the perpendicular distance from the watermain to the sewer or drain line is at least ten feet.
 5. Installed watermain or service shall be pressure-tested in accordance with DuPage County
- Department of Public Works prior to final acceptance.
- 6. Installed watermain or service shall be disinfected and tested according to the requirements of the "Standards for Disinfecting Watermains", AWWA C-601, and as required by county code. All disinfection, as required, shall be performed by an independent firm exhibiting experience in the methods and techniques of this operation.
- 7. All new plumbing fixtures must bear the water sense label. DO NOT REMOVE THE WATERSENSE LABEL PRIOR TO PASSING THE FINAL INSPECTION AND HAVE FIXTURE CUT SHEETS ONSITE FOR FINAL INSPECTION.
- 8. A stack test is required on all waste and vent piping at the time of rough and underground inspections.
- 9. 75 psi air test or water on required on all water piping at time of rough inspection.



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SHEET TITLE Utility Plan


SHEET NUMBER

5.2

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Project Num	ber 999-1117				
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LEGEND	

1"W	Water Line
SAN	Sanitary Sewer Line
)	Storm Sewer Line
0	Drain Structure
\wedge	Outlet Structure
	Perforated Pipe

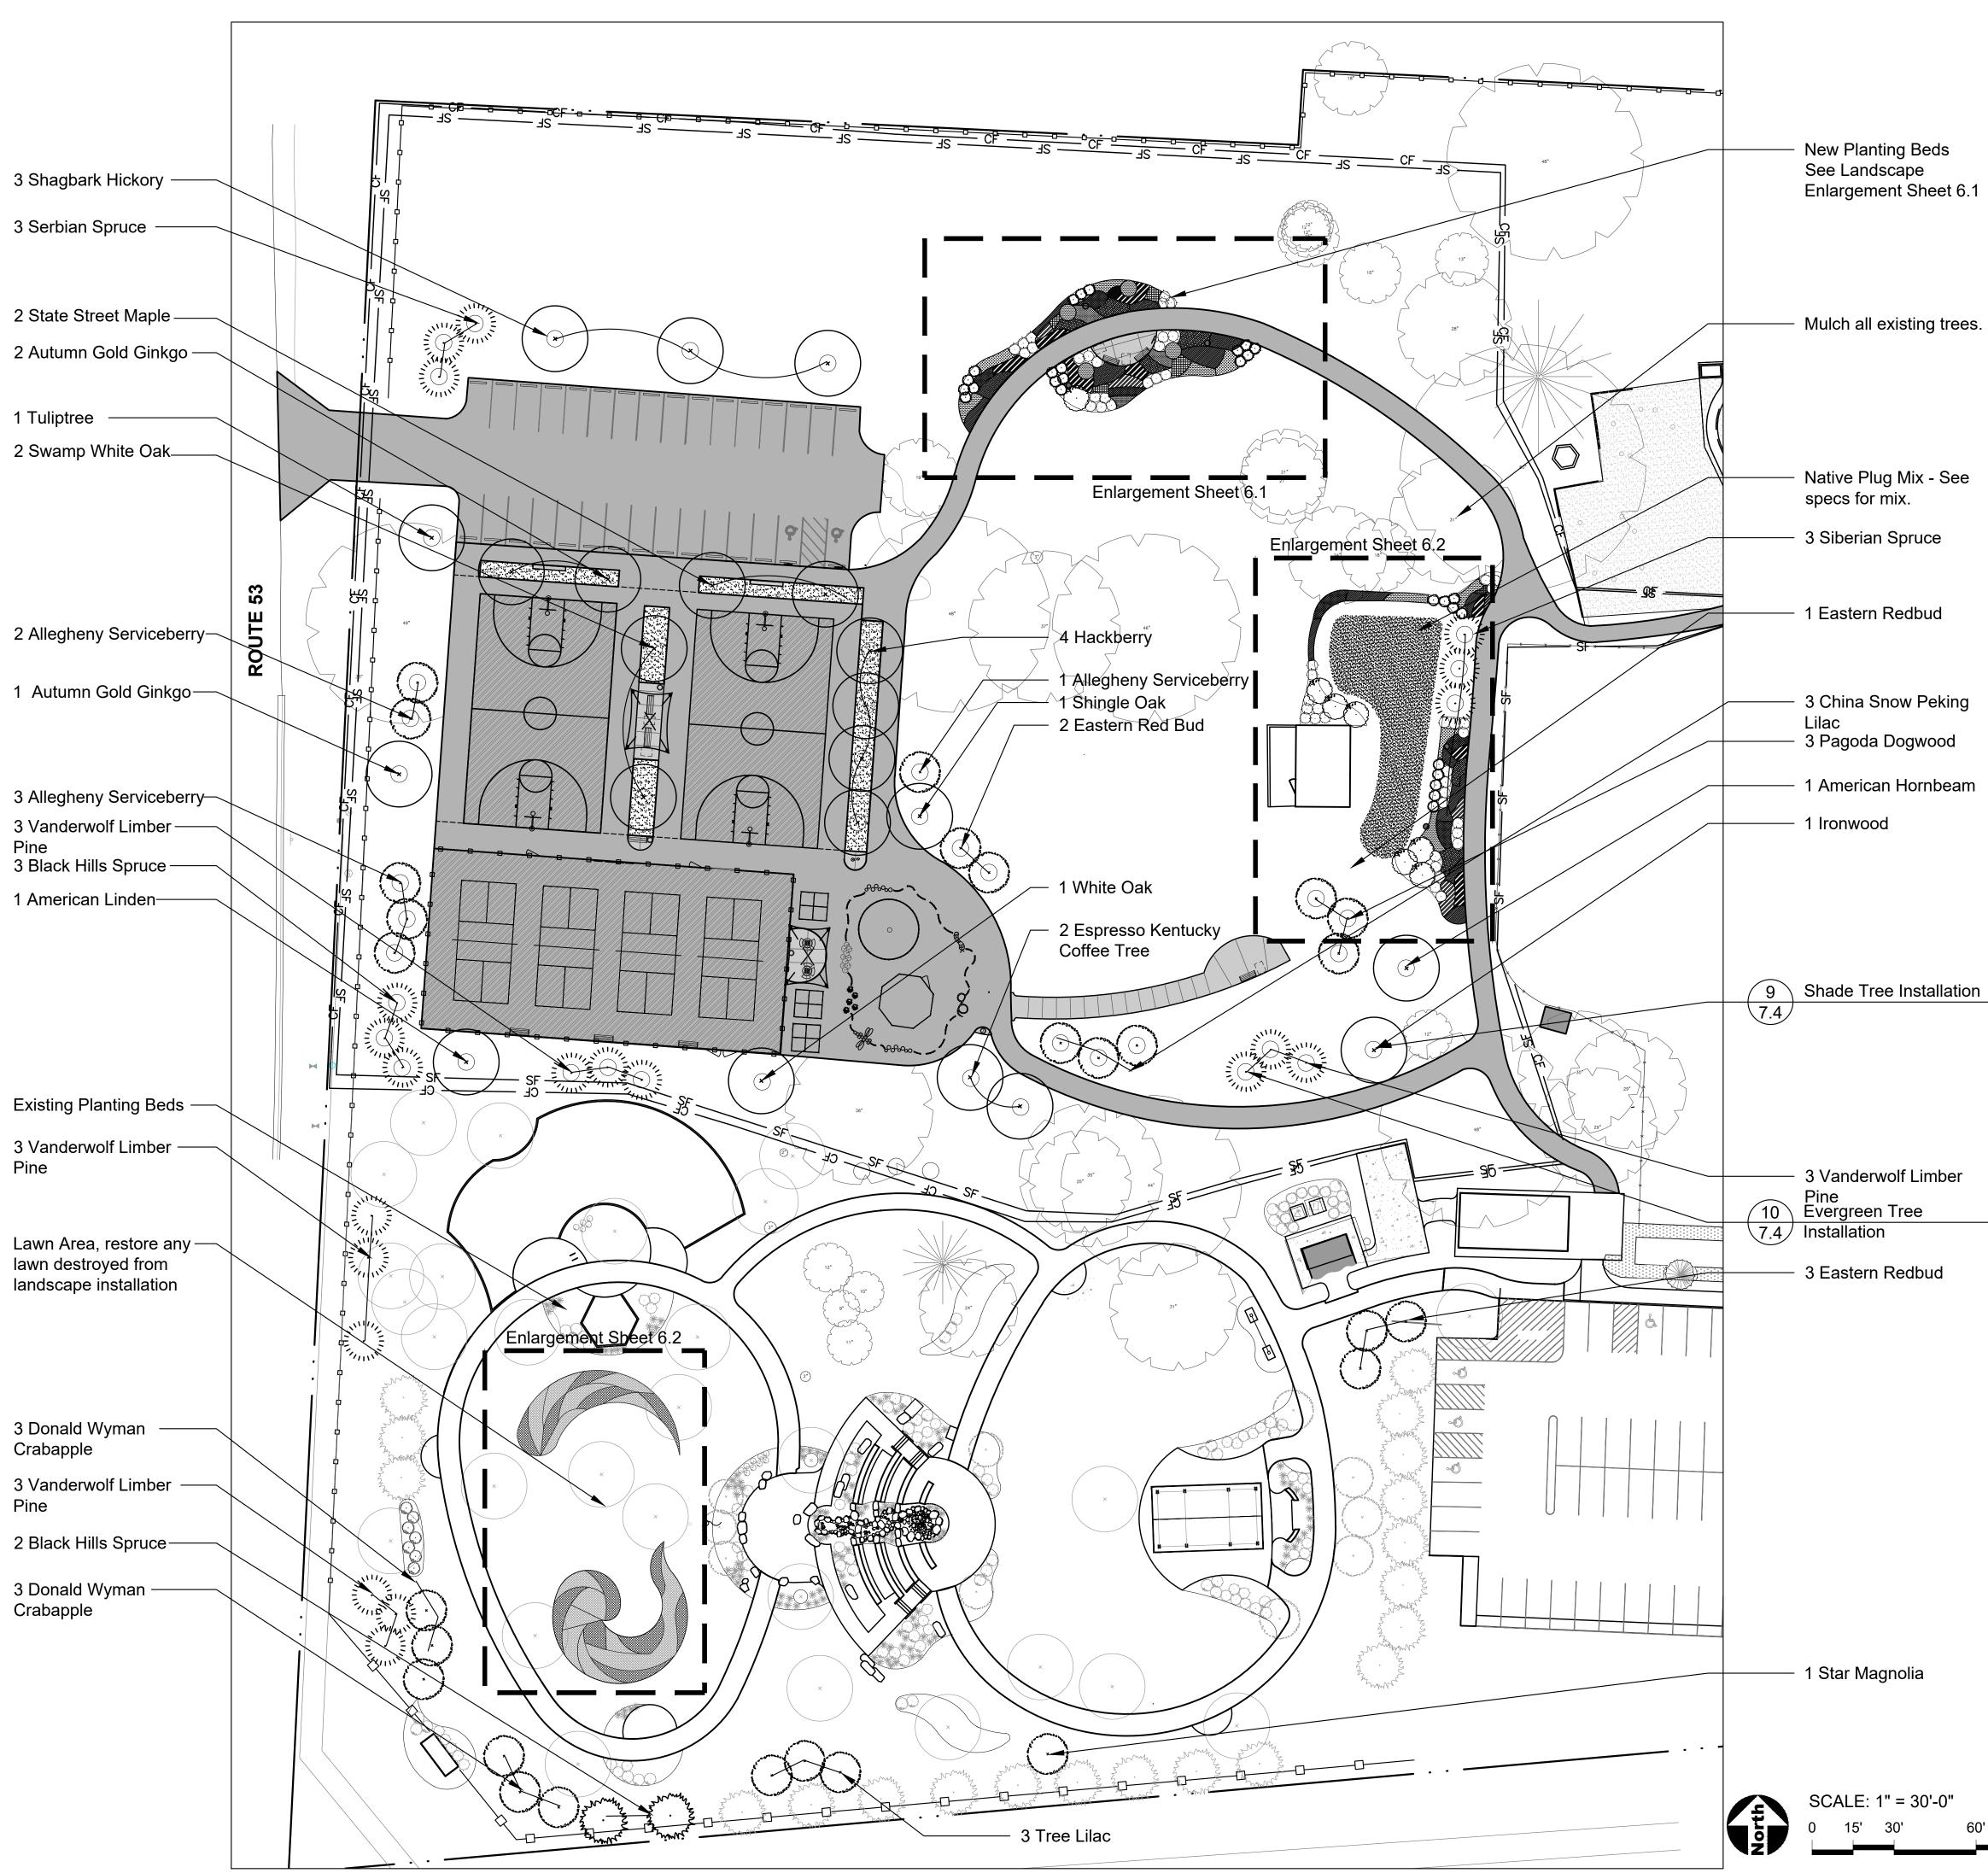

GENERAL NOTES: LANDSCAPE

- Notes indicated on grading plans shall pertain to landscape plans. Final grade of planting 1 beds shall be as per grading plan.
- The landscape contractor shall be responsible for making themselves familiar with all underground utilities and structures.
- All existing plant material and trees shall be saved and protected unless otherwise noted. 3. Contractor to protect new and existing trees and landscaping from damage and shall restore all areas disturbed as a result of construction.
- Plant material shall be supplied from Northern Illinois nursery stock, shall be dug the planting 4. season it is installed, and shall conform to the American Association of Nurseryman's standards.
- Plant material shall be size and type specified. Substitution of plant material shall be on a case by case basis and approved in writing by the Owner's Representative. In no case shall plant material be smaller than indicated in the plans.
- Do not willfully proceed with plantings as designed when it is obvious that obstructions and/or grade differences exist that may not have been known during the design process. Such conditions shall be immediately brought to the attention of the Owner's Representative.
- All plant material shall be inspected and approved by the Owner's Representative prior to the installation of any and all plant material.
- Plant locations shall be flagged in field with Owner's Rep. Final location of all plant material shall be subject to approval of the Owner's Representative prior to digging any holes. The landscape contractor is responsible for providing Owner's Representative with 48 hour minimum advance notice prior to planting.
- Plants shall be watered on the day they are planted and maintained with watering until final 9. acceptance of the project.
- 10. Apply a pre-emergent as per manufacturer's specification prior to installing mulch. Beds and tree rings (6' diameter) shall have 3" of hardwood shredded mulch applied and a 11.
- 4" deep spade edge at lawn. Trees that are not located in beds, shall have a tree ring. 12. Landscape plant material shall be guaranteed for 12 months from final acceptance. Any plant 1/3 dead or more shall be replaced under the guarantee.
- 13. Contractor to prepare landscape beds by roto-tilling 2" of Mushroom Compost into new beds. Do not add compost nor roto-till within drip line of existing trees.
- 14. Lawn Seeding shall be under favorable weather conditions, and shall follow dates in
- specification. All irrigation shall be installed and functioning prior to seeding. 15. Turf mixes shall be installed and lawn established at all disturbed areas.
- 16. Do not overseed into mulch beds, artificial turf, and paving.
- 17. Contractor shall restore all areas disturbed as a result of construction.
- 18. Landscape contractor to coordinate all work with irrigation work.



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PROJECT

Glenbriar OSLAD Phase III Development

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SHEET TITLE

Landscape Plan

SHEET NUMBER



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		•

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Shade Tree

+

Evergreen Tree

Ornamental Tree

Shrub

Ornamental Grass

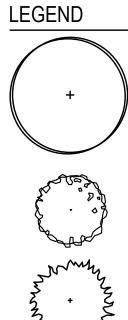
Perennial and Groundcover (hatch symbol varies)

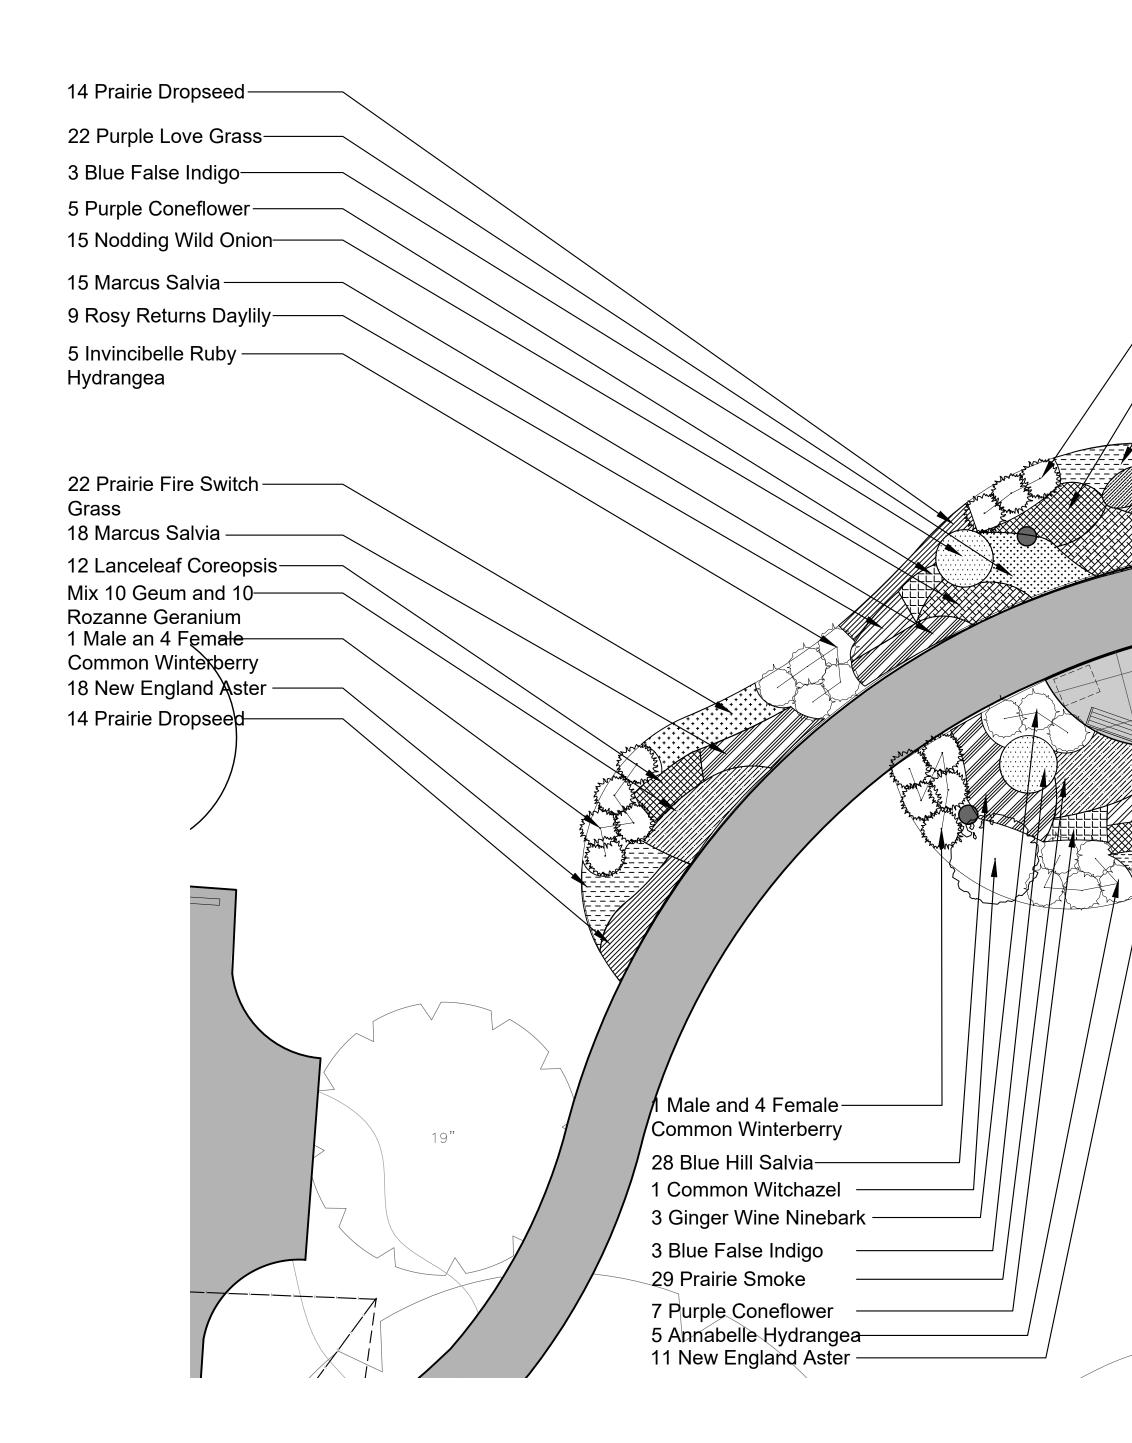
Rain Garden Seed Mix

------ CF ------ Construction Limits / Construction Fence

Note: See Sheet x.x for Landscape Details, and see specifications for the seed mix information.

90





GENERAL NOTES: LANDSCAPE

1. See Sheet 6.0 for landscape notes

- 3 Dense Yew

/ 19 Lanceleaf Coreopsis — 15 New England Aster

Plant List

Qty.	Size	Botanical Name	Common Name
2	2.5" cal.	Acer miyabei 'Morton'	State Street Miyabe's Maple
1	2.5" cal.	Carpinus caroliniana	American Hornbeam
3	2.5" cal.	Carya ovata	Shagbark Hickory
4	2.5" cal.	Celtis occidentalis	Hackberry
3	2.5" cal.	Ginkgo biloba 'Autumn Gold'	Autumn Gold Ginkgo
2	2.5" cal.	Gymnocladus dioicus 'Espresso'	Espresso Kentucky Coffeetree Tree
1	2.5" cal.	Liriodenron tulipifera	Tuliptree
1	2.5" cal.	Ostrya virginiana	Ironwood
2	2.5" cal.	Quercus bicolor	Swamp White Oak
1	2.5" cal.	Quercus alba	White Oak
1	2.5" cal.	Quercus imbricaria	Shingle Oak
1	2.5" cal.	Tilia americana	American Linden
20	Total		

Ornamental Trees - Balled and Burlap

Qty.	Size	Botanical Name	Common Name
6	6' High	Amelanchier laevis	Allegheny Serviceberry
6	6' High	Cersis canadensis	Eastern Redbud
6	6' High	Malus 'Donald Wyman'	Donaly Wyman Crabapple
1	6' High	Magnolia stellata 'Royal Star'	Star Magnolia
6	6' High	Syringa pekinensis 'Morton'	China Snow Peking Lilac
25	Total		

Evergreen Trees - Balled and Burlap

Qty.	Size	Botanical Name	Common Name
5	2.5" cal.	Picea glauca var. densata	Black Hills Spruce
6	2.5" cal.	Picea omorika	Serbian spruce
12	2.5" cal.	Pinus flexilis 'Vanderwolf's Pyramid'	Vanderwolf Limber Pine
23	Total		

Evergreen Shrubs - Balled and Burlap or Pot

۱ty.	Size	Botanical Name	Common Name
8	24" Ht. x 24" Spr.	Taxus x media 'Densiformis'	Dense Yew
4	24" Ht. x 24" Spr.	llex verticillata	Male Common winterberry
16	24" Ht. x 24" Spr.	llex verticillata	Female Common winterberry
28	Total		
	-		

Qty.	Size	Botanical Name	Common Name
3	#5 cont., 24" Ht.	Aronia melanocarpa 'Morton' Iroquois Beauty	Black Chockeberry
12	#5 cont., 24" Ht.	Hydrangea arborescens 'Annabelle'	Annabelle Hydrangea
11	24" Ht. x 24" Spr.	Hydrangea arborescens 'NCHA3'	Invincibelle Ruby Hydrangea
1	24" Ht. x 24" Spr.	Hamamelis virginiana	Common witchazel
17	#5 cont., 24" Ht.	Physocarpus opulifolius 'SMNPOBLR'	Ginger Wine Ninebark
3	#5 cont., 24" Ht.	Syringa 'Charles Joly'	Charles Joly Lilac
3	#5 cont., 24" Ht.	Viburnum dentatum ' Christom' Blue Muffin	Blue Muffin Arrowwood Viburnum
20	Total		

Perennials, Ornamental Grasses, and Groundcovers

Qty.	Size	Botanical Name	Common Name	
12	#1cont.	Achillea millefolium 'Moonshine'	Moonshine Yarrow	
50	#1cont.	Allium cernuum	Nodding Wild Onion	
8	#1cont.	Asclepias incarnata 'Soulmate'	Milkweed	
33	#1cont.	Asclepias tuberosa 'Gay Butterflies'	Butterfly Weed	
27	#1cont.	Baptisia australis	Blue False Indigo	
108	#1cont.	Coreopsis lanceolata	Lanceleaf Coreopsis	
32	#1cont.	Echinacea purpurea	Purple Coneflower	
55	#1cont.	Eragrostis spectabilis	Purple Lovegrass	
38	#1cont.	Geranium 'Gerwat' Rozanne	Rozanne Geranium	
69	#1cont.	Geum flora plena 'Blazing Sunset'	Geum	
43	#1cont.	Geum triflorum	Prairie Smoke	
72	#1cont.	Hemerocallis 'Apricot Sparkles'	Apricot Sparkles Daylily	
9	#1cont.	Hemerocallis 'Rosy Returns'	Rosy Returns Daylily	
35	#1 cont.	Liatris aspera	Rough Blazing Star	
69	#1 cont.	Panicum virgatum 'Prairie Fire'	Prairie Fire Switch Grass	
56	#1 cont.	Salvia nemorosa 'Haeumanarc'	Marcus Salvia	
99	#1 cont.	Salvia x sylvestris 'Blauhugel'	Blue Hill Salvia	
117	#1cont.	Sporobolus heterolepis	Prairie Dropseed	
97	#1cont.	Symphyotrichum novae-angliae	New England Aster	
1029	Total			

8 Milkweed — 3 Blue False Indigo — Mix 12 Nodding Wild Onion and 12 Rough Blazing Star — 20 Blue Hill Salvia 12¹2" — 14 Prairie Smoke 12", 15" - Mix 5 Purple Coneflower and 5 Moonshine Yarrow 3 Ginger Wine Ninebark 7 Perennial & Ornamental 7.4 Grass Installation 8 Shrub Installation Qt 7.4 1 Male and 4 Female Common Winterberry Mix 10 Geum with 10 Rozanne Geranium 21 Prairie Fire Switch Grass Mix 14 Nodding Wild Onion with 14 Rough Blazing Star Mix 25 Prairie Dropseed with 15 Blue Hill Salvia 3 Ginger Wine Ninebark 3 Blue False Indigo - 19 New England Aster - 15 Purple Love Grass Wix 10 Purple Coneflower - Mix 9 Nodding Wild Onion 2 with 7 Moonshine Yarrow with 9 Rough Blazing Star 3 Invincibelle Ruby Hydrangea 16 Blue Hill Salvia - 31 Apricot Sparkles Daylily 16 Lanceleaf Coreopsis



SCALE: 1" = 10'-0"

10'

20'

30'

Deciduous Shrubs - Balled and Burlap or Pot



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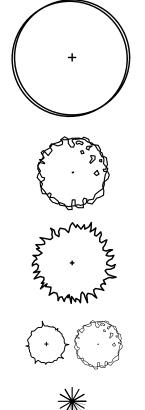


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LEGEND



Shade Tree

Ornamental Tree

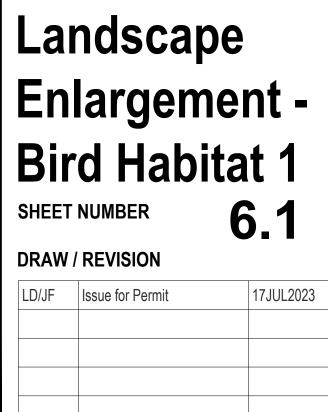
Evergreen Tree

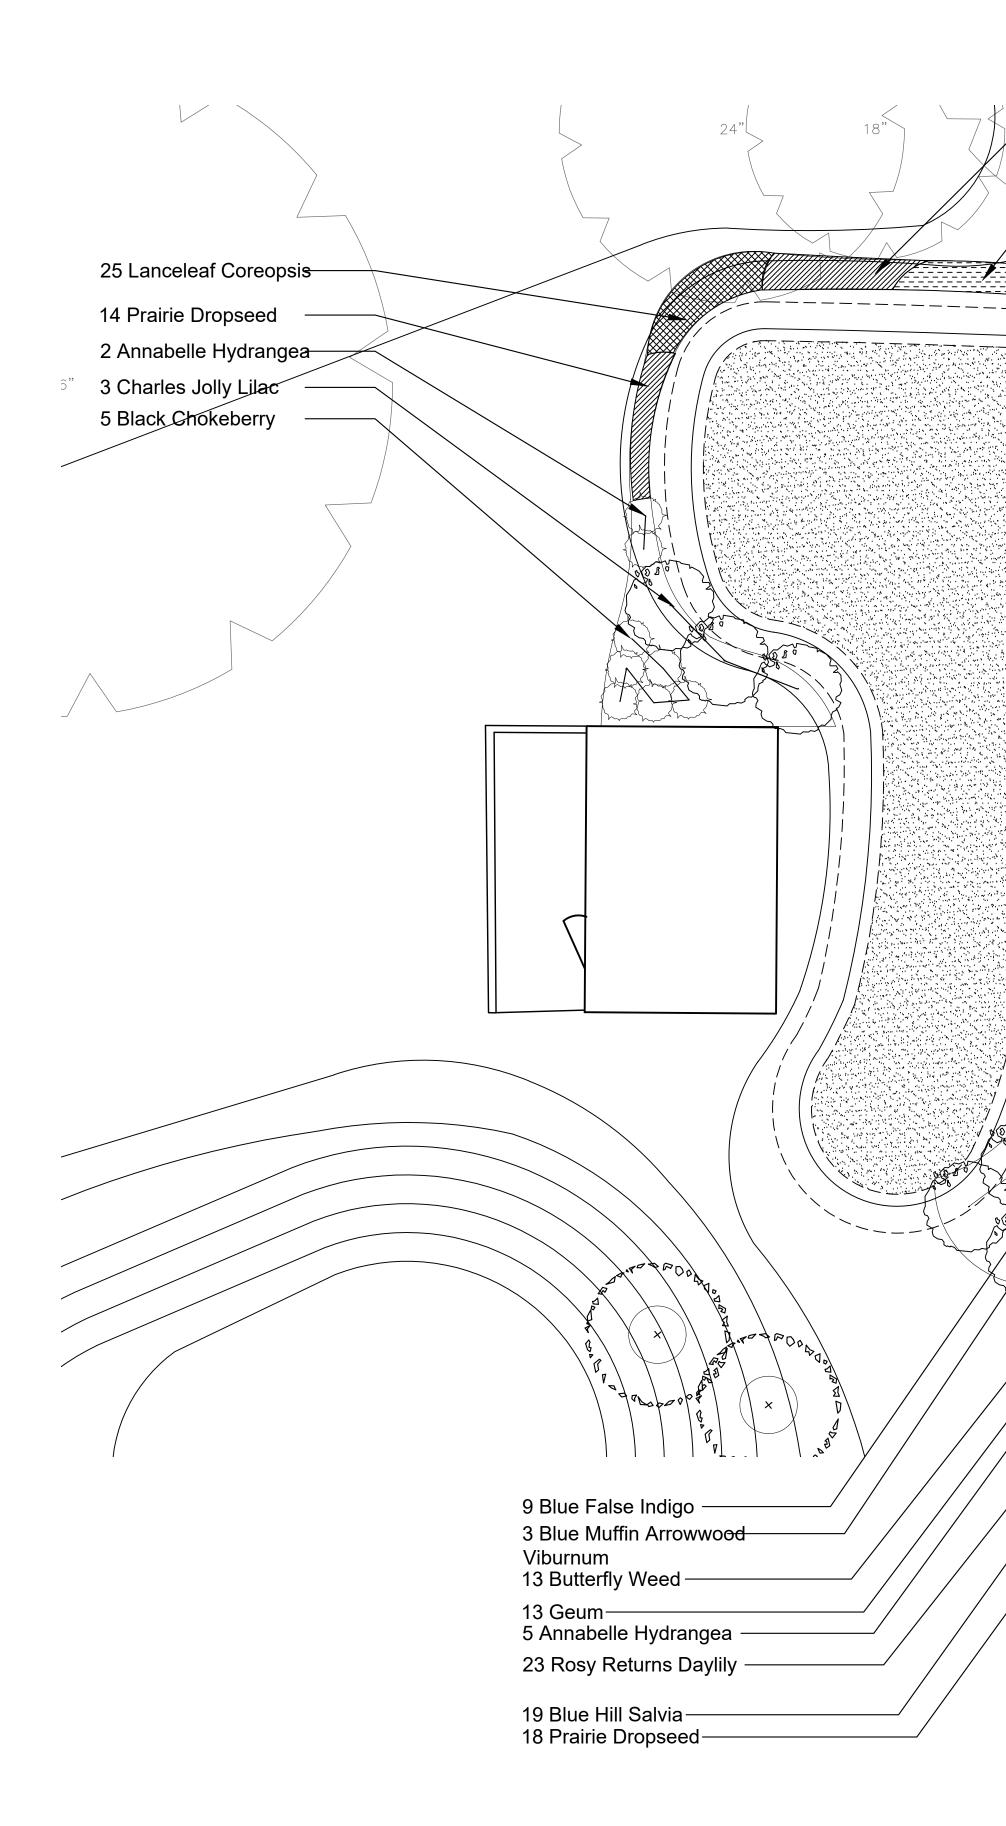
Shrub

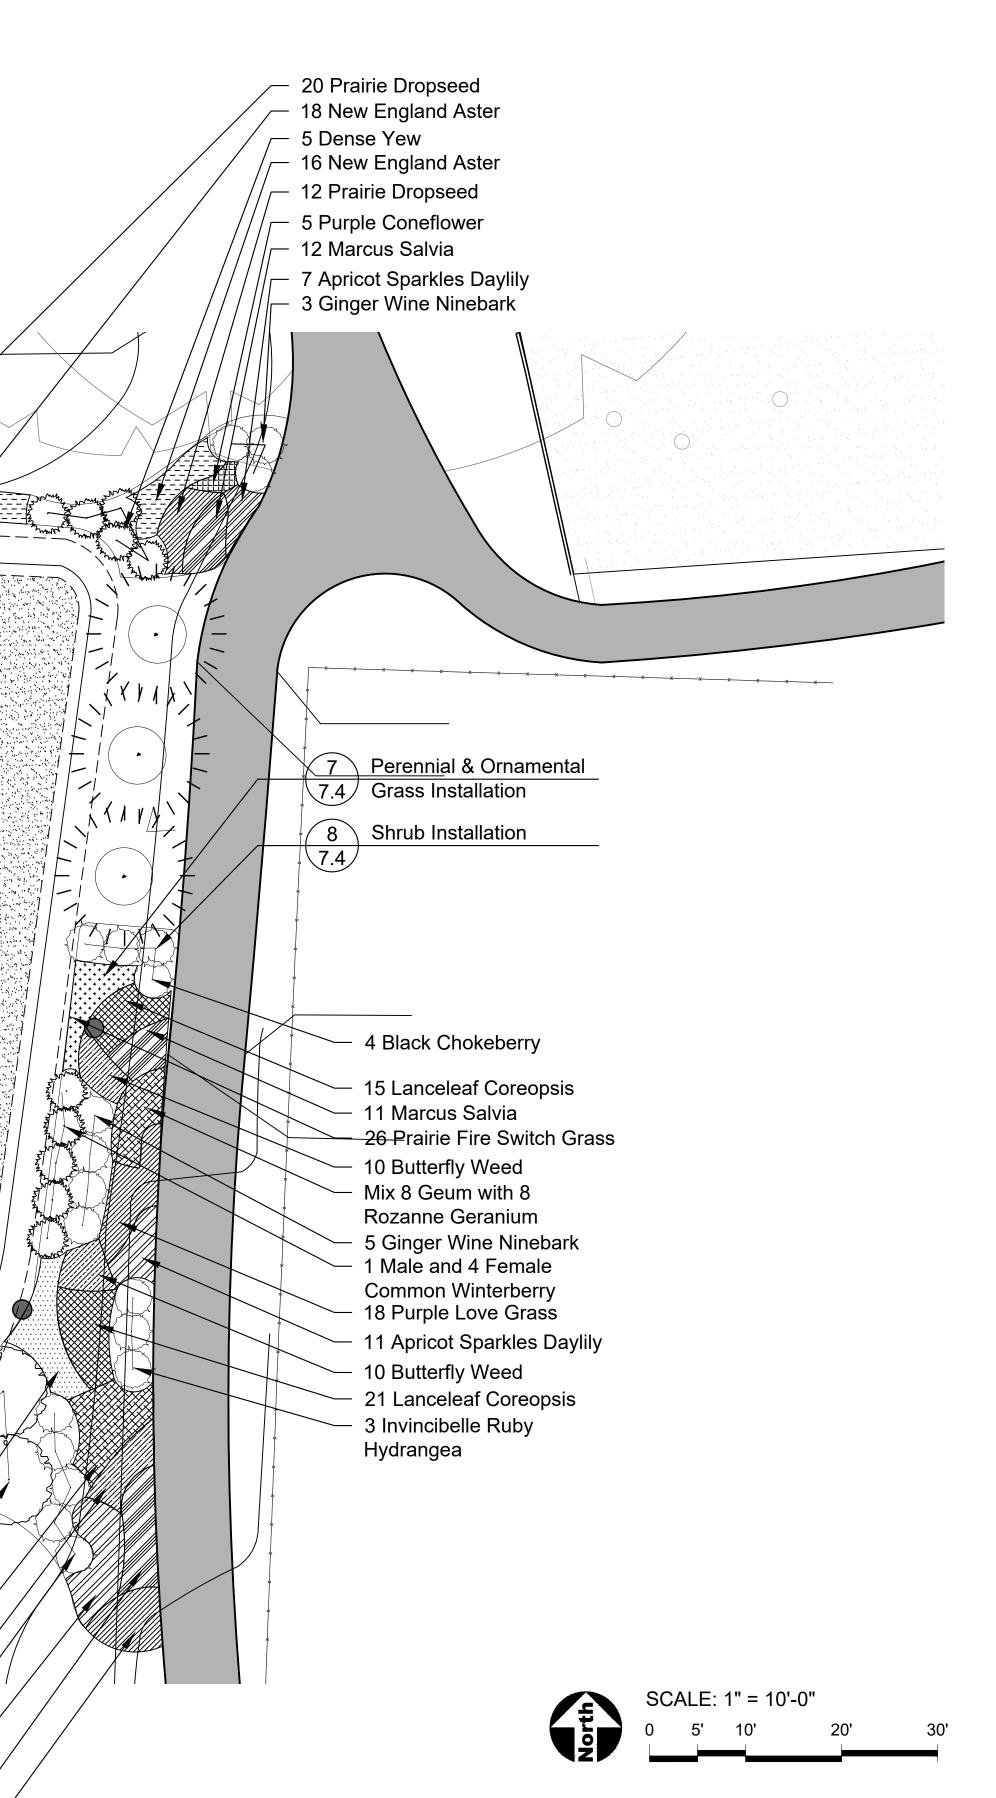
Ornamental Grass

Perennial and Groundcover (hatch symbol varies)

SHEET TITLE







GENERAL NOTES: LANDSCAPE

1. See Sheet 6.0 for landscape notes.



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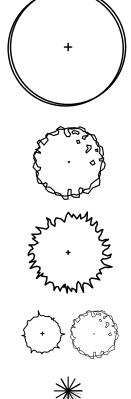


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LEGEND



Shade Tree

Ornamental Tree

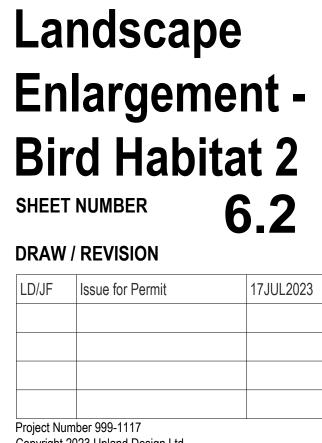
Evergreen Tree

Shrub


Ornamental Grass

Perennial and Groundcover (hatch symbol varies)

SHEET TITLE



Interplant			
23 - Narcissus 'Pink Charm'	\mathbf{i}		
23 - Narcissus 'Double Cheerfulness'			
23 - Ocean Magic Grape Hyacinth			/
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23 - Narcissus 'Tete a tete'	\backslash \backslash		/
23 - Narcissus 'Mount Hood'			/
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23 - Narcissus 'Tahiti'			/
23 - Poet's Narcissus			/
23 - Blue Magic Grape Hyacinth			/
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23 - Narcissus 'Pink Charm'			
23 - Narcissus 'Trumpet Dutch Master'	'		
23 - Blue Magic Grape Hyacinth			
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23 - Narcissus 'Barrett Browning'			
23 - Narcissus 'Ara'			
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23 - Narcissus 'Thalia'			
23 - Narcissus 'Ice Follies'			
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2. Bulbs shall be planted Fall 2023 and coordinate with irrigation plans.

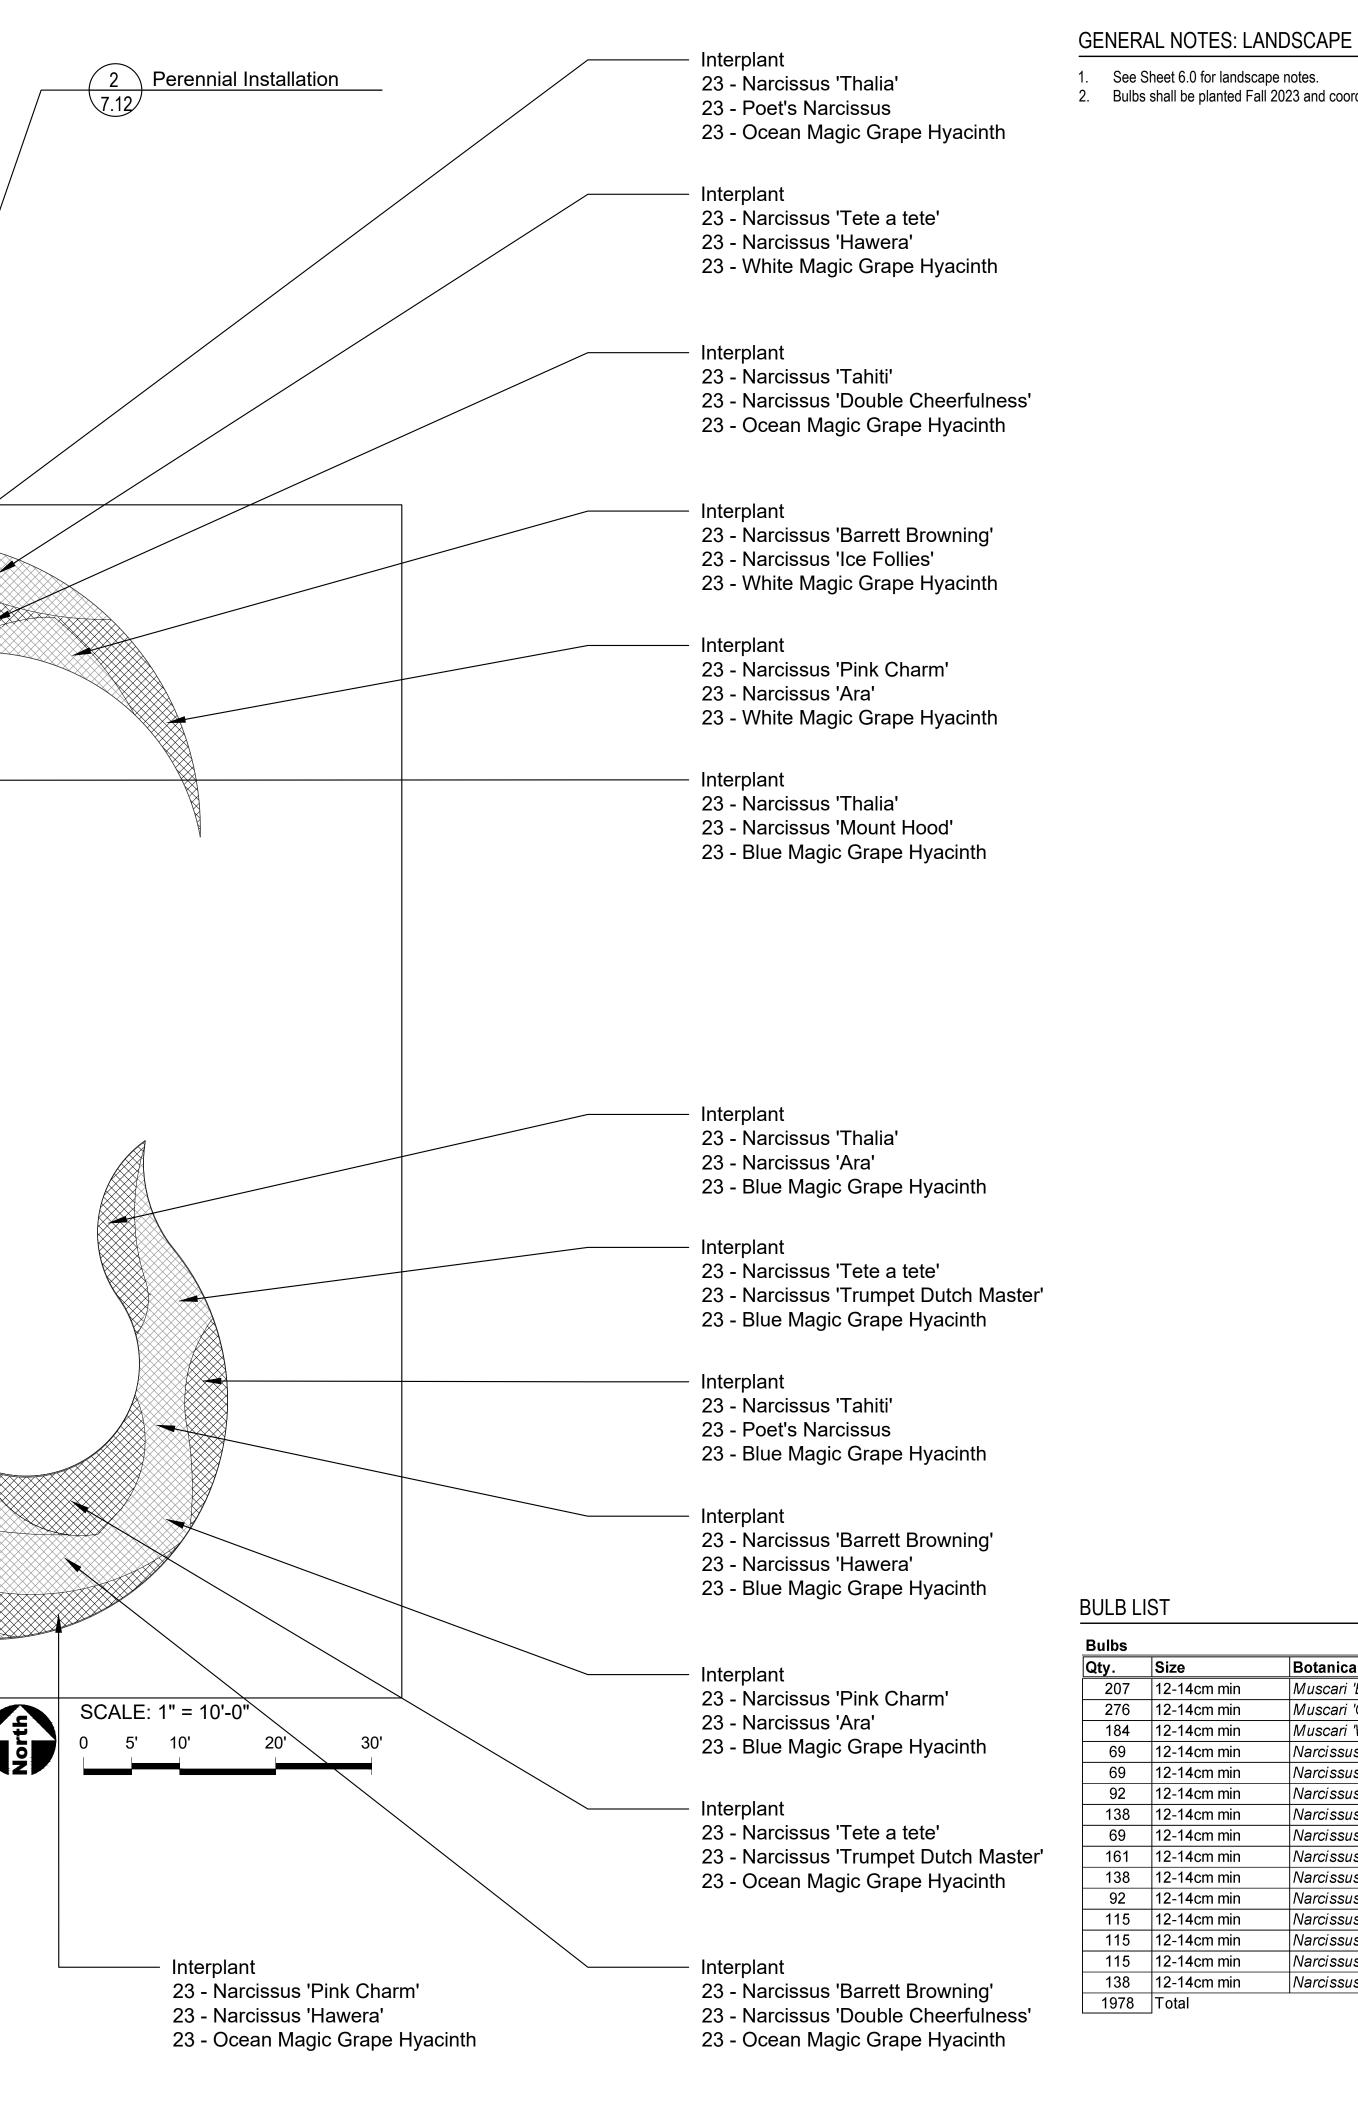

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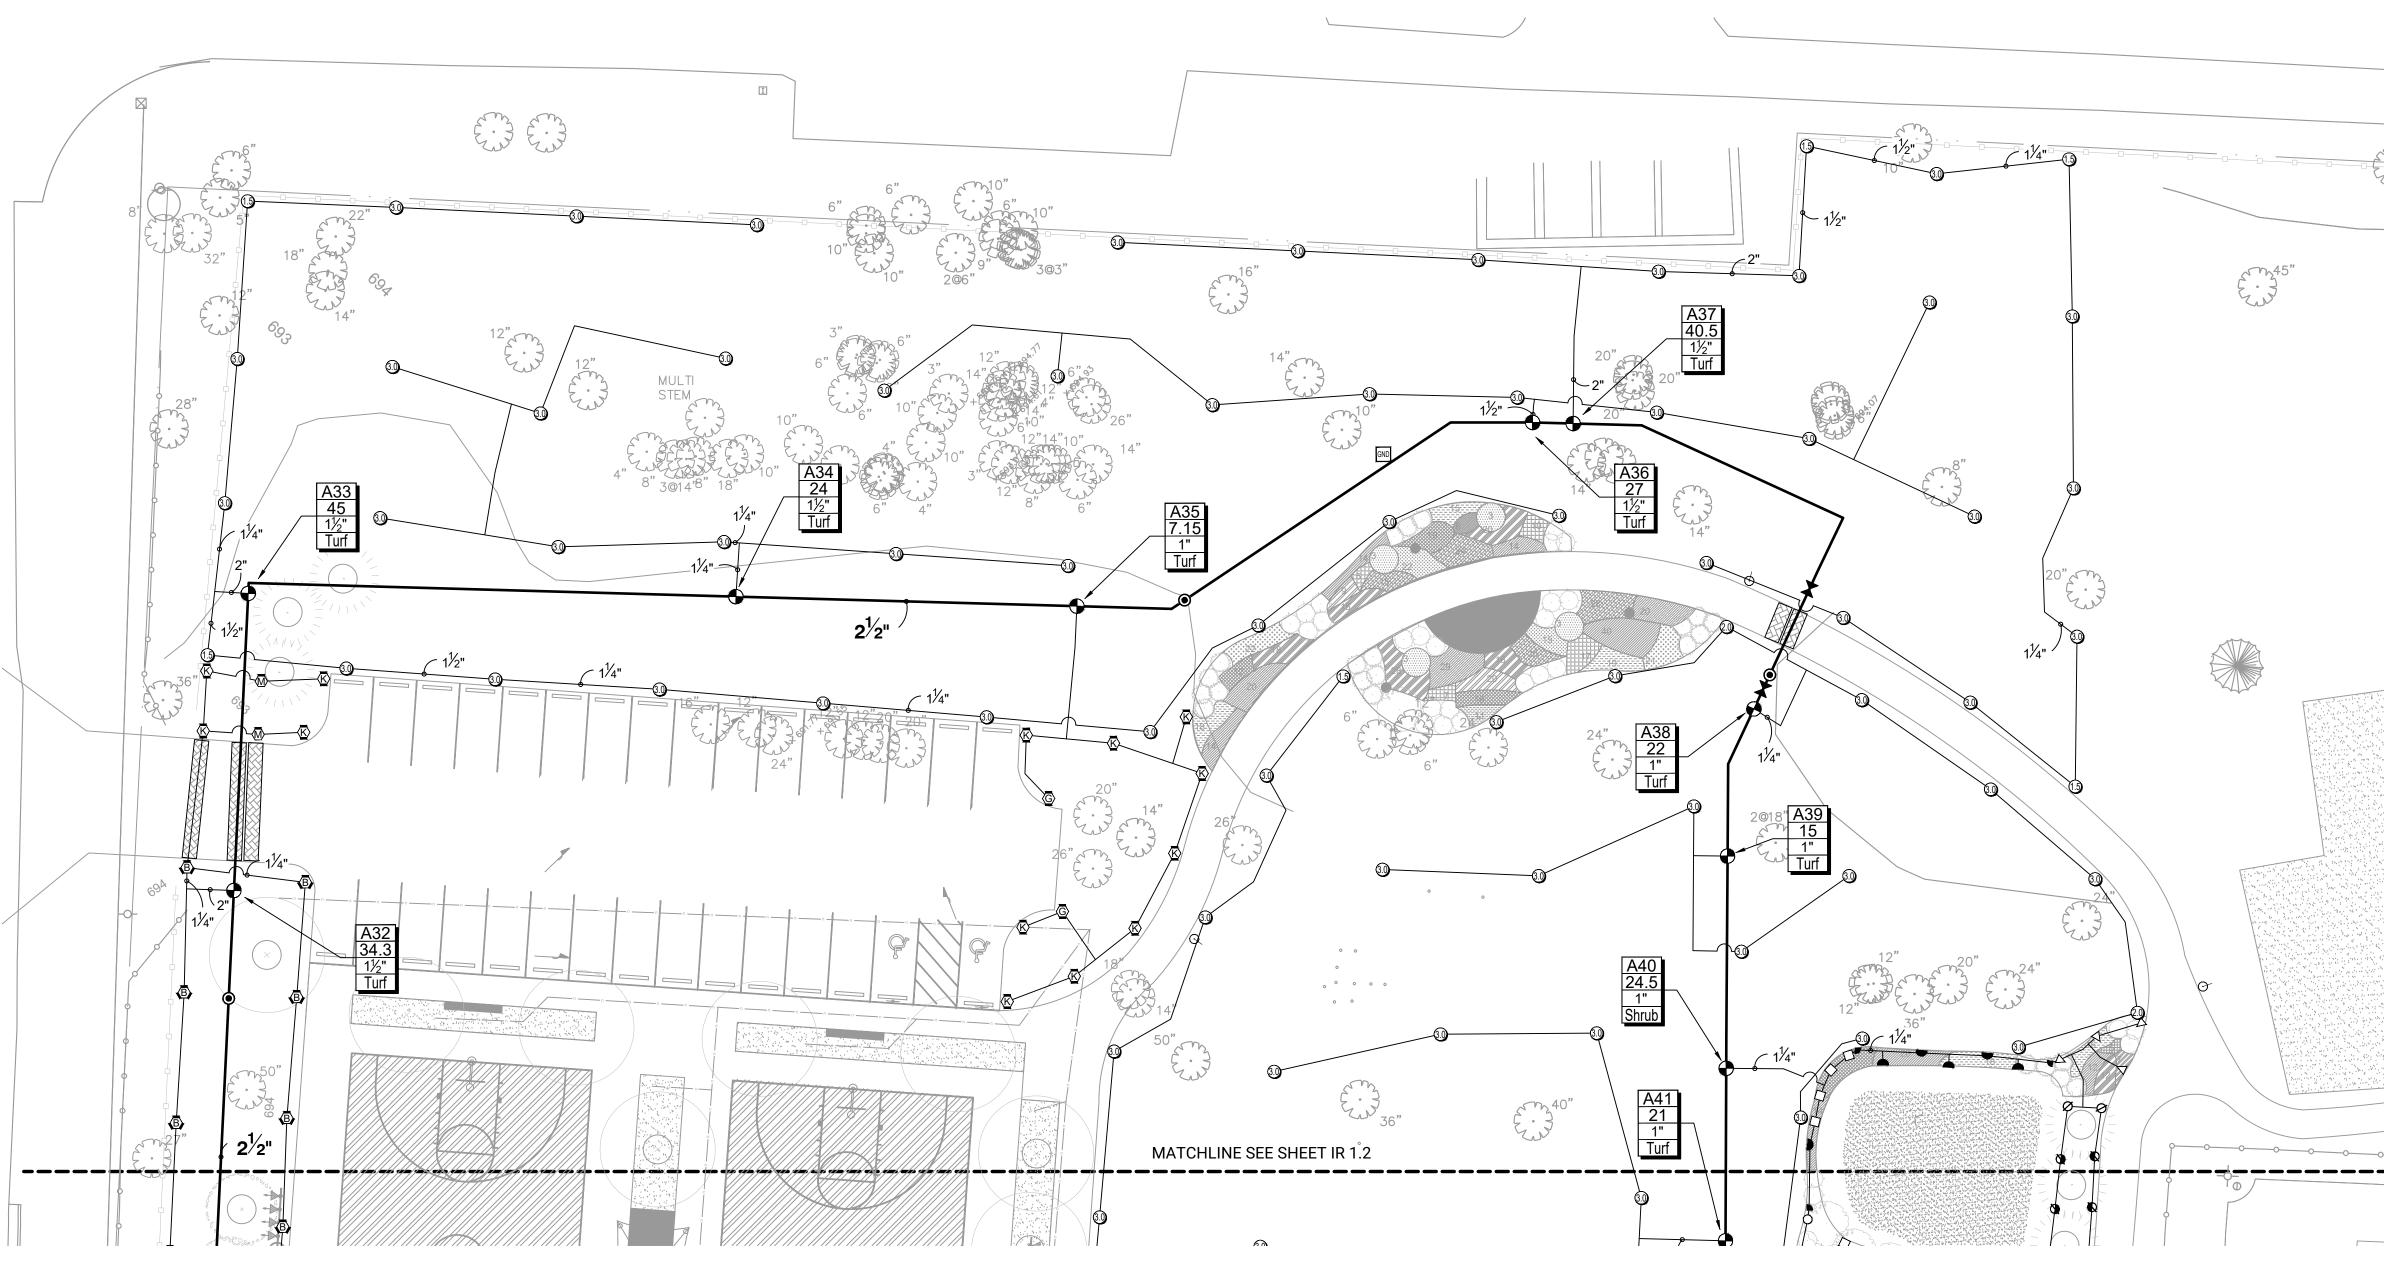
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SHEET TITLE



DRAW / REVISION			
LD/JF	Issue for Permit	17JUL2023	
Project Number 000 1117			

Botanical Name Common Name Blue Magic Grape Hyacinth Muscari 'Blue Magic' Ocean Magic Grape Hyacinth Muscari 'Ocean Magic' White Magic Grape Hyacinth Muscari 'White Magic' Narcissus poeticus var. recurvus Poet's Narcissus Daffodil 'Ice Follies' Narcissus 'Ice Follies' Daffodil 'Mount Hood' Narcissus 'Mount Hood' Daffodil 'Tete a tete' Narcissus 'Tete a tete' Triandrus Daffodil Narcissus 'Hawera' Narcissus 'Pink Charm' Daffodil 'Pink Charm' Narcissus 'Barrrett Browning' Daffodil 'Barrett Browning' Narcissus 'Trumpet Dutch Master' Daffodil 'Trumpet Dutch Master' Daffodil 'Double Cheerfulness' Narcissus 'Cheerfulness' Daffodil 'Thalia' Narcissus 'Thalia' Narcissus 'Tahiti' Daffodil 'Tahiti' Daffodil 'Ara' Narcissus 'Ara'



INSTALLATION GENERAL NOTES

- 1. THE SYSTEM DESIGN ASSUMES A MINIMUM DYNAMIC PRESSURE FOR THE IRRIGATION SYSTEM OF 80 PSI (PER CITY ENGINEER), AT A DESIGN FLOW OF 88 GPM AT THE 2-INCH IRRIGATION POINT-OF-CONNECTION (POC). TAP, METER, BACKFLOW PREVENTER, MASTER VALVE AND FLOW METER SHALL BE SIZED AS INDICATED IN THE DRAWING LEGEND. VERIFY PRESSURE AND FLOW ON SITE PRIOR TO CONSTRUCTION.
- 2. READ THOROUGHLY AND BECOME FAMILIAR WITH THE SPECIFICATIONS AND INSTALLATION DETAILS FOR THIS AND RELATED WORK PRIOR TO CONSTRUCTION.
- 3. COORDINATE UTILITY LOCATES ("CALL BEFORE YOU DIG") OF UNDERGROUND UTILITIES PRIOR TO CONSTRUCTION.
- 4. DO NOT PROCEED WITH THE INSTALLATION OF THE IRRIGATION SYSTEM WHEN IT IS OBVIOUS IN THE FIELD THAT OBSTRUCTIONS OR GRADE DIFFERENCES EXIST THAT MIGHT NOT HAVE BEEN CONSIDERED IN THE ENGINEERING. IF DISCREPANCIES IN CONSTRUCTION DETAILS, LEGEND, NOTES, OR SPECIFICATIONS ARE DISCOVERED, BRING ALL SUCH OBSTRUCTIONS OR DISCREPANCIES TO THE ATTENTION OF THE OWNER'S REPRESENTATIVE.
- 5. THE DRAWINGS ARE DIAGRAMMATIC. THEREFORE, THE FOLLOWING SHOULD BE NOTED:
- A. ALTHOUGH IRRIGATION COMPONENTS MAY BE SHOWN OUTSIDE PLANTING AREAS FOR CLARITY, INSTALL IRRIGATION PIPE AND WIRING IN LANDSCAPED AREAS WHENEVER POSSIBLE.
- B. TREE AND SHRUB LOCATIONS AS SHOWN ON LANDSCAPE PLANS TAKE PRECEDENCE OVER IRRIGATION EQUIPMENT LOCATIONS. AVOID CONFLICTS BETWEEN THE IRRIGATION SYSTEM, PLANTING MATERIALS, AND ARCHITECTURAL FEATURES.
- C. USE ONLY STANDARD TEES AND ELBOW FITTINGS. USE OF TEES IN THE BULLNOSE CONFIGURATION, OR USE OF CROSS TYPE FITTINGS IS NOT ALLOWED.

- 6. PROVIDE THE FOLLOWING COMPONENTS TO THE OWNER PRIOR TO THE COMPLETION OF THE PROJECT:
- A. TWO (2) OPERATING KEYS FOR EACH TYPE OF MANUALLY OPERATED VALVES.
- B. TWO (2) OF EACH SERVICING WRENCH OR TOOL NEEDED FOR COMPLETE ACCESS, ADJUSTMENT, AND REPAIR OF ALL ROTARY SPRINKLERS.
- 7. SELECT NOZZLES FOR SPRAY AND ROTARY SPRINKLERS WITH ARCS WHICH PROVIDE COMPLETE AND ADEQUATE COVERAGE WITH MINIMUM OVERSPRAY FOR THE SITE CONDITIONS. CAREFULLY ADJUST THE RADIUS OF THROW AND ARC OF COVERAGE OF EACH ROTARY SPRINKLER TO PROVIDE THE BEST PERFORMANCE.
- 8. THE IRRIGATION CONTRACTOR IS RESPONSIBLE FOR THE INSTALLATION OF IRRIGATION SLEEVING. SLEEVES ARE REQUIRED FOR BOTH PIPING AND ELECTRICAL WIRING AT EACH HARDSCAPE CROSSING. COORDINATE INSTALLATION OF SLEEVING WITH OTHER TRADES. ANY PIPE OR WIRE WHICH PASSES BENEATH EXISTING HARDSCAPE WHERE SLEEVING WAS NOT INSTALLED WILL REQUIRE HORIZONTAL BORING BY THE IRRIGATION CONTRACTOR. PIPE SLEEVES SHALL BE SIZED TWICE THE NOMINAL SIZE OF THE PIPE PASSING THROUGH.
- 9. INSTALL ALL ELECTRICAL POWER TO THE IRRIGATION CONTROL SYSTEM IN ACCORDANCE WITH THE NATIONAL ELECTRIC CODE AND ALL APPLICABLE LOCAL ELECTRIC UTILITY CODES.
- 10. THE FOLLOWING SHOULD BE NOTED REGARDING PIPE SIZING: IF A SECTION OF UNSIZED PIPE IS LOCATED BETWEEN TWO IDENTICALLY SIZED SECTIONS, THE UNSIZED PIPE IS THE SAME NOMINAL SIZE AS THE TWO SIZED SECTIONS. THE UNSIZED PIPE SHOULD NOT BE CONFUSED WITH THE DEFAULT PIPE SIZE NOTED IN THE LEGEND.
- 11. INSTALL ONE (1) #14 AWG TWO-WIRE PAIR ON TWO-WIRE SYSTEMS , FOR USE AS SPARES. INSTALL SPARE WIRES FROM CONTROLLER LOCATION TO EACH DEAD-END OF MAINLINE. COIL 3 FEET OF WIRE IN VALVE BOX.

CONSTRUCTION NOTES

- 1 THE IRRIGATION SYSTEM POINT-OF-CONNECTION (POC) SHALL BE DOWNSTREAM OF THE IRRIGATION WATER TAP AND METER INSTALLED BY OTHERS AT THE APPROXIMATE LOCATION SHOWN. INSTALL BACKFLOW PREVENTION UNIT AND MASTER VALVE ASSEMBLY AS INDICATED. VERIFY EXACT LOCATION OF POC WITH OWNER'S REPRESENTATIVE.
- 2 WALL MOUNT THE IRRIGATION CONTROLLER AT THE APPROXIMATE LOCATION SHOWN. COORDINATE ELECTRICAL POWER TO THE CONTROLLER WITH THE OWNER'S REPRESENTATIVE. CARE SHOULD BE TAKEN TO INSTALL THE IRRIGATION CONTROLLER IN A LOCATION THAT IS ACCESSIBLE FOR MAINTENANCE, AND SCREENED FROM VIEW EITHER BEHIND ENTRY WALLS, NEXT TO BUILDINGS, OR BEHIND PLANT MATERIAL. FINAL LOCATION TO BE APPROVED BY OWNER'S REPRESENTATIVE.
- (3) IRRIGATION LINES AND HEADS LOCATED WITHIN TREE PROTECTION FENCES [TPF] SHALL BE INSTALLED BY HAND TO AVOID DAMAGE TO EXISTING TREES.

ESTIMATED ANNUAL WATER USE

THE IRRIGATION SYSTEM AS SHOWN ON THIS PLAN HAS AN ESTIMATED ANNUAL WATER USE OF 2,029,960 GALLONS. TO VERIFY EFFICIENT IRRIGATION SYSTEM OPERATION, THE OWNER SHALL COMPARE THIS ESTIMATED IRRIGATION WATER USE WITH ACTUAL WATER USE, AS RECORDED ON SITE, AFTER ALL PLANT MATERIAL HAS BEEN ESTABLISHED.

THE ESTIMATED ANNUAL IRRIGATION WATER USE OF THIS SYSTEM IS BASED ON 30-YEARS AVERAGE EVAPOTRANSPIRATION RATES (ET) FOR THE LOCAL AREA AND TYPICAL NEW IRRIGATION SYSTEM EQUIPMENT EFFICIENCIES. MAJOR DEVIATIONS FROM THIS ESTIMATE USE SHOULD BE BROUGHT TO THE ATTENTION OF THE OWNER AND CURRENT IRRIGATION MAINTENANCE COMPANY AT THE TIME OF THE DEVIATION.

TO VERIFY EFFICIENT IRRIGATION SYSTEM OPERATION AND WATER USE, AN IRRIGATION SYSTEM EVALUATION AND AUDIT SHOULD BE PERFORMED.

IRRIGATION SLEEVE LEGEND

* ALL SLEEVES SHALL BE CLASS 200 PVC AND SIZED TWICE THE NOMINAL SIZE OF THE PIPE PASSING THROUGH, ALL CONTROL WIRE SLEEVES SHALL BE 2-INCH

IRRIGATION LEGEND

SLEEVES: CLASS 200 PVC

POINT-OF-CONNECTION ASSEMBLY

- MAINLINE PIPE: CLASS 200 PVC 2 1/2-INCH SIZE UNLESS OTHERWISE INDICATED
 LATERAL PIPE TO SPRINKLERS: CLASS 200 PVC 1-INCH SIZE UNLESS OTHERWISE INDICATED
- REMOTE CONTROL VALVE ASSEMBLY FOR SPRINKLER LATERALS: HUNTER ICV (SIZED PER PLAN) W/ICD-100 DECODER
- QUICK COUPLING VALVE ASSEMBLY: HUNTER HQ-5RC
- ISOLATION GATE VALVE ASSEMBLY: MATCO 514
- F FLOW SENSOR ASSEMBLY: HUNTER HFS WITH FCT-200 W/FLOW CLICK SENSOR
- BACKFLOW PREVENTION ASSEMBLY: FEBCO 825YA (2")
- MASTER VALVE ASSEMBLY: IRRITROL 100P1.5 N.O. VALVE W/ ICD-100 DECODER DECODER CABLE FUSE DEVICE (DCFD) WITH LIGHTNING PROTECTION: PAIGE P7407D

	IN
A1	IN
14	
1"	IN
Turf	
	IN


INDICATES CONTROLLER AND STATION NUMBER
 INDICATES LATERAL DISCHARGE (GPM)

- INDICATES VALVE SIZE (INCHES)
- INDICATES LANDSCAPE APPLICATION
- (A) IRRIGATION CONTROLLER UNIT WITH HUNTER WRF-CLIK SENSOR A2C-LTE COMMUNICATION MODULE

HUNTER ACC2 2 WIRE CONTROLLER

POP-UP GEAR DRIVEN ROTORS: HUNTER I-20-06-SS PRESSURE: 45 PSI

	PRESSURE	=:45 PSI		
	NOZZLE	RADIUS	FLOW	_
1.5	1.5	31'	1.5 GPM	_
2.0	2.0	34'	2.0 GPM	
25	2.5	35'	2.5 GPM	
3.0	3.0	38'	3.0 GPM	
4.0	4.0	40'	4.0 GPM	
5.0	5.0	42'	5.0 GPM	
6.0	6.0	43'	6.0 GPM	
8.0	8.0	44'	8.0 GPM	

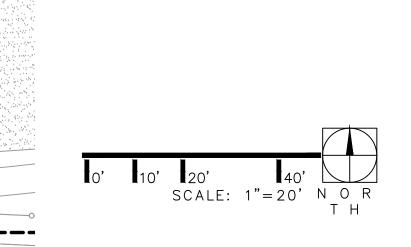

♦ ■ POP-UP SPRAY SPRINKLER: HUNTER PROS-12-PRS30-CV W/8 SERIES NOZZLE PRESSURE: 30 PSI RADIUS: 8 FEET FLOW (GPM): Q-0.24 H-0.47 F-0.97


- POP-UP SPRAY SPRINKLER: HUNTER PROS-12-PRS30-CV W/10 SERIES NOZZLE PRESSURE: 30 PSI RADIUS: 10 FEET FLOW (GPM): Q-0.42 H-0.88 F-1.59
- ▲ ▲ POP-UP SPRAY SPRINKLER: HUNTER PROS-12-PRS30-CV W/12 SERIES NOZZLE PRESSURE: 30 PSI RADIUS: 12 FEET FLOW (GPM): Q-0.67 H-1.30 F-2.70
- POP-UP SPRAY SPRINKLER: HUNTER PROS-12-PRS30-CV W/15 SERIES NOZZLE PRESSURE: 30 PSI RADIUS: 15 FEET FLOW (GPM): Q-0.97 H-1.86 F-3.75
- □ [©] △ ^O POP-UP SPRAY SPRINKLER: HUNTER PROS-12-PRS30-CV W/ ADJUSTABLE NOZZLE PRESSURE: 30 PSI RADIUS: 5 FEET TO 15 FEET FLOW (GPM): 08A-0.44 10A-0.50 12A-0.32 15A-0.47
- POP-UP SPRAY SPRINKLER: HUNTER PROS-12-PRS30-CV W/15SS SERIES NOZZLE PRESSURE: 30 PSI RADIUS: 5 FEET X 15 FEET FLOW (GPM): ES515-0.65 SS530-1.30
- POP-UP ROTATING SPRAY SPRINKLER: HUNTER PROS-06-PRS40-CV W/MP1000 NOZZLES
 PRESSURE: 40 PSI RADIUS: 8 FEET TO 15 FEET
 FLOW (GPM): M-0.42 L-0.63 0-0.84
- Image: Second Structure Structure
- POP-UP ROTATING SPRAY SPRINKLER: HUNTER PROS-06-PRS40-CV W/MP3000 NOZZLES PRESSURE: 40 PSI RADIUS: 22 FEET TO 30 FEET FLOW (GPM): B-1.82 Y-2.73 A-3.64
- POP-UP ROTATING SPRAY SPRINKLER: HUNTER PROS-06-PRS40-CV W/MPCORNER NOZZLE
 PRESSURE: 40 PSI RADIUS: 8 FEET TO 14 FEET
 FLOW (GPM): 45°-0.19 90°-0.39 105°-0.45
- (5) (5) (5) POP-UP ROTATING SPRAY SPRINKLER: HUNTER PROS-06-PRS40-CV W/MPSTRIP NOZZLES PRESSURE: 40 PSI RADIUS: ADJUSTABLE RECTANGULAR SPRAY FLOW (GPM): SST - 5'X30'-0.22 LCS/RCS - 4'X15'-0.44

21W730 Butterfield Rd Lombard, Illinois 60148 Phone: 630-858-2229

PROJECT

Glenbriar OSLAD Phase III Development

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Landscape Architecture & Park Planning Chicago, Illinois 312-350-4088 Plainfield, Illinois 815-254-0091 uplandDesign.com
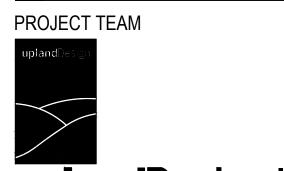
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Zeitler Consulting, Inc. 1130 Randville, Unit 1B Palatine, Illinois 60074 Phone: 224-220-6030




SITE WATER ENGINEERING SERVICES 323 W. DRAKE RD, SUITE 204 FORT COLLINS, COLORADO 80526 Telephone: 970.282.1800 Web: www.hinesinc.com

SHEET TITLE IRRIGATION PLAN

SHEET NUMBER IR-1.1 DRAW / REVISION

		1
LD/JF	50% Submittal	15JUN2023
DM/MT	100% Submittal	30JUN2023
DM/MT	REVISIONS	04AUG2023

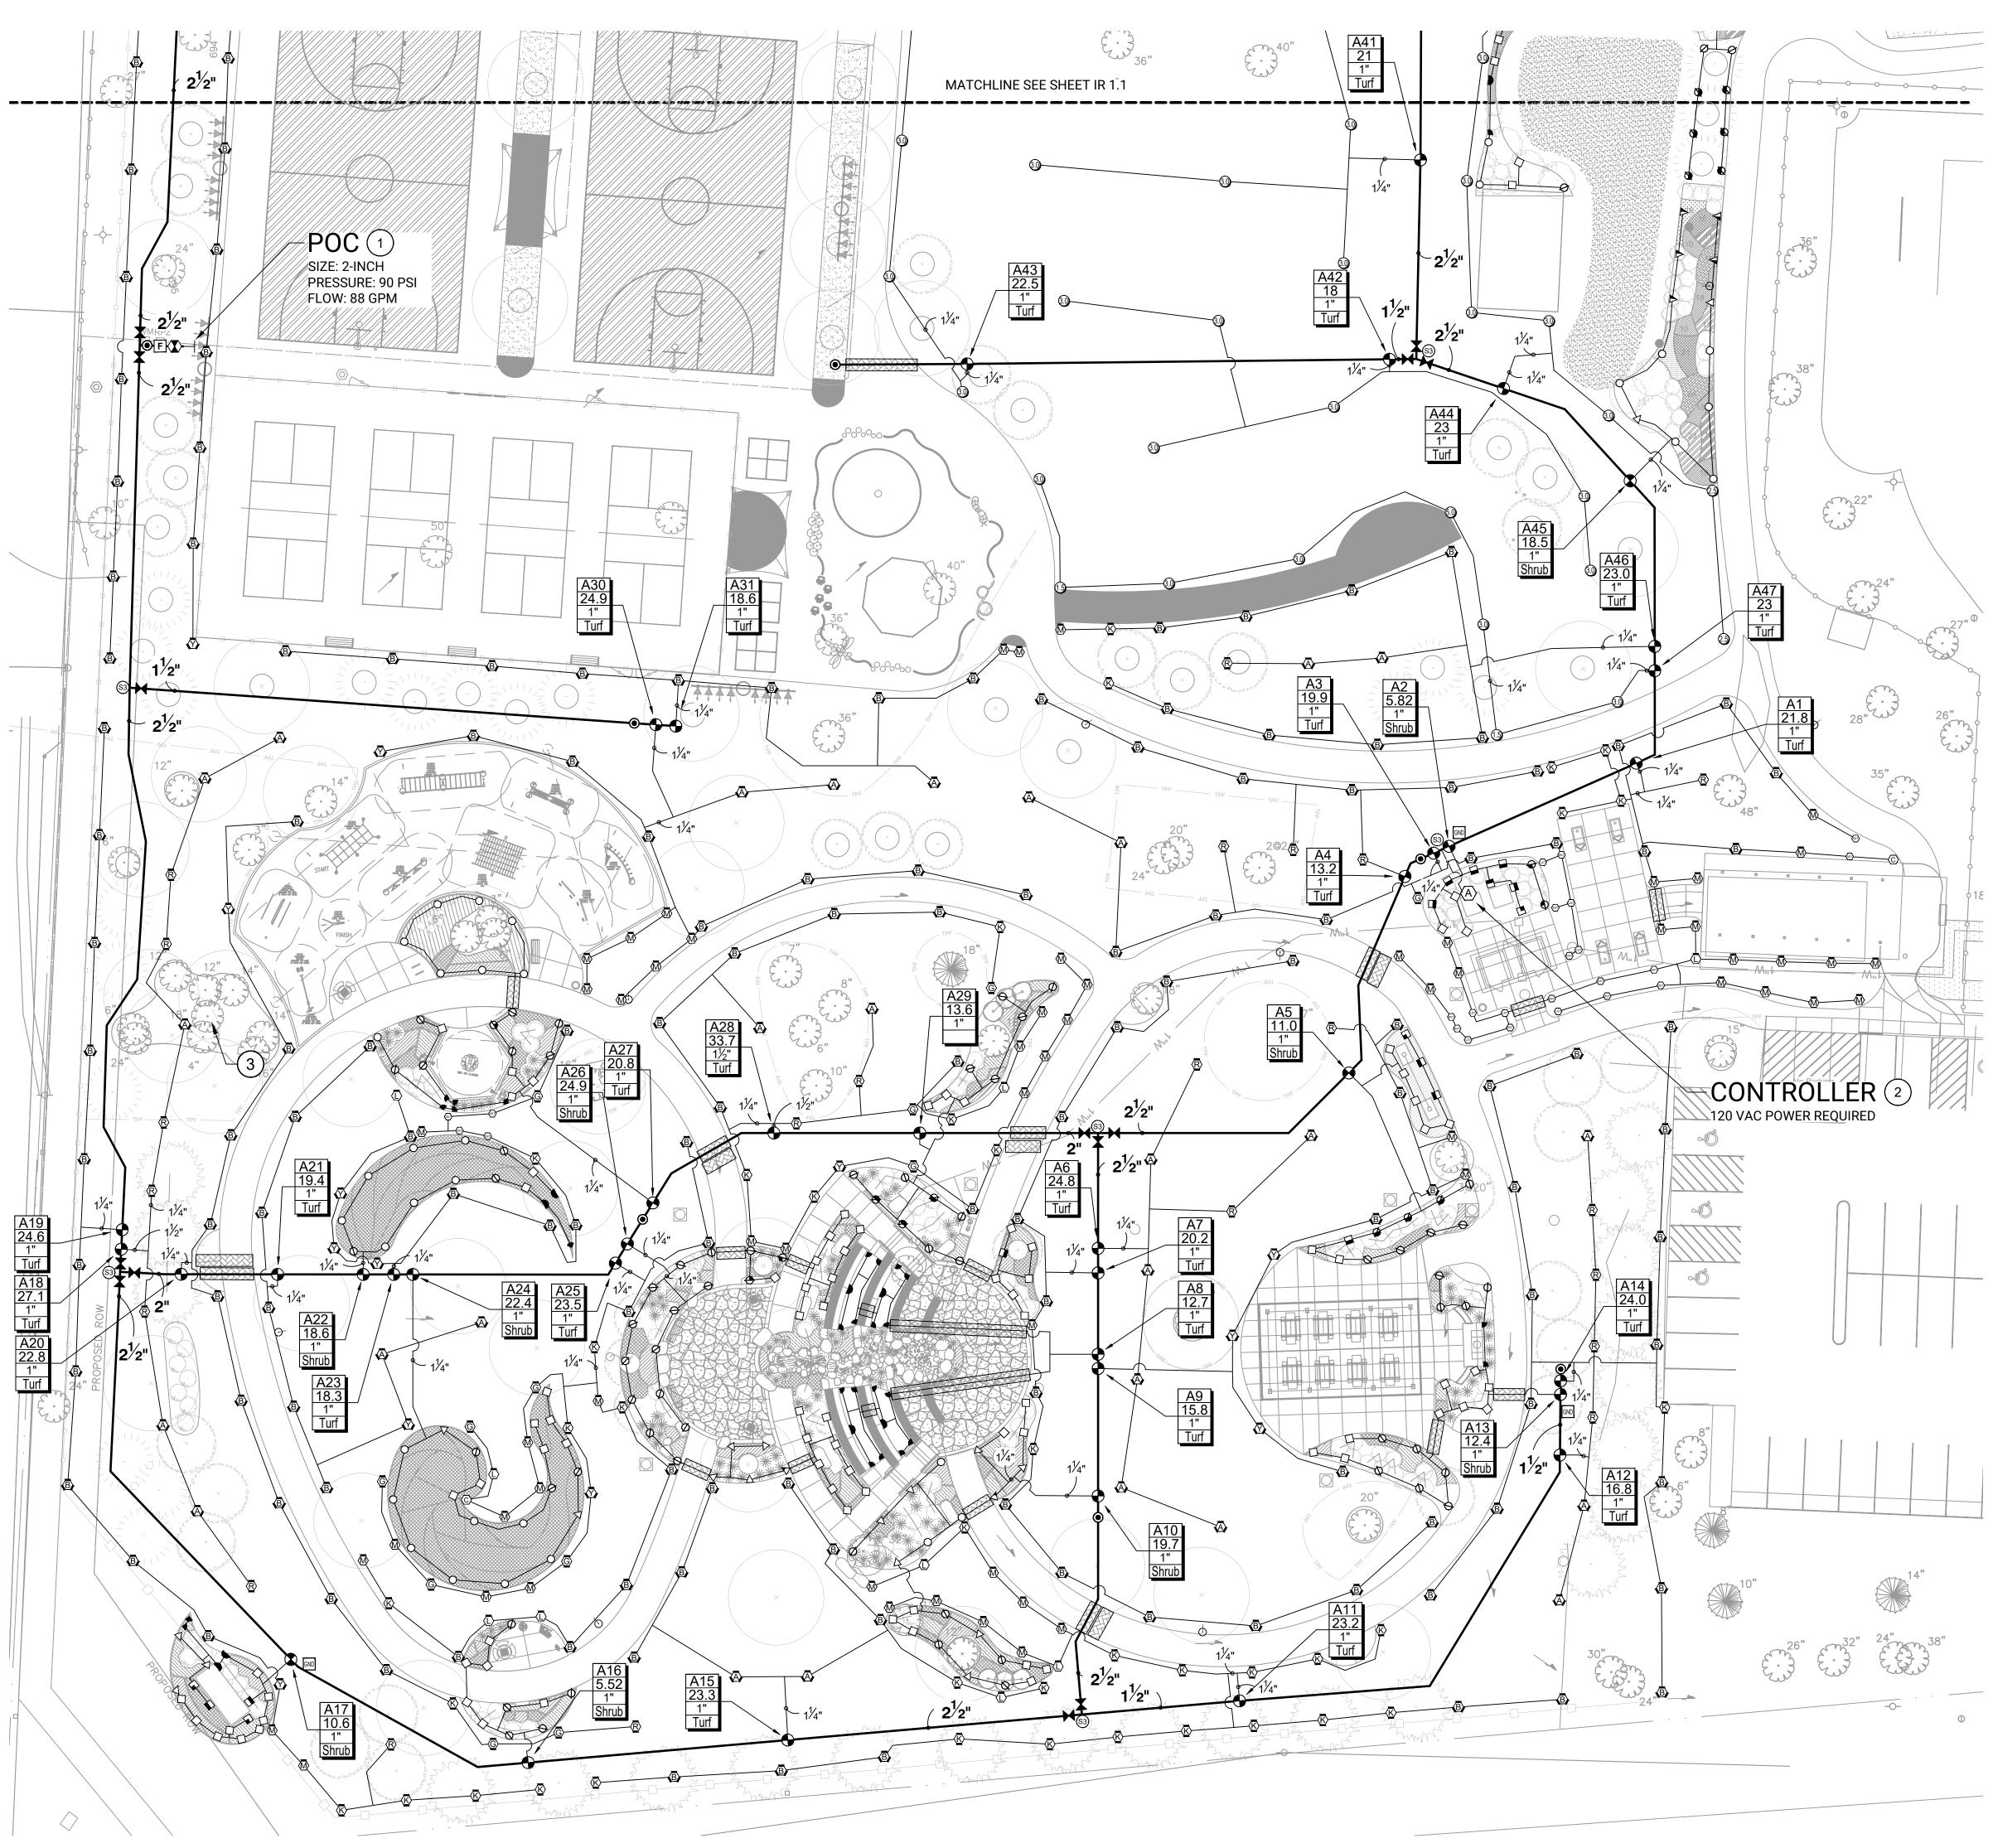

0' 10' 20' 40' 40' SCALE: 1"=20' N O R T H

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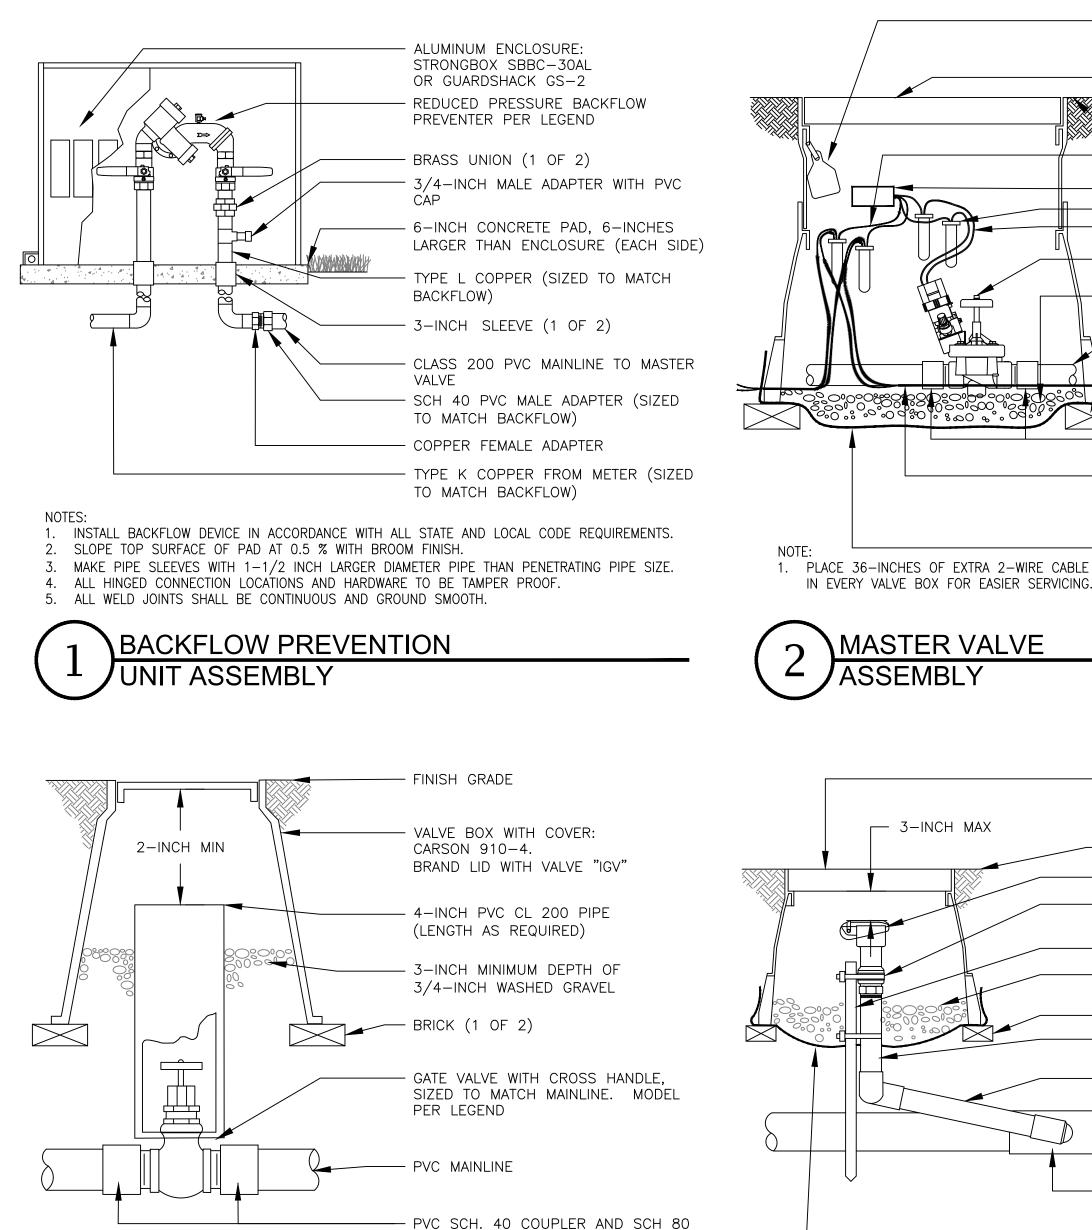


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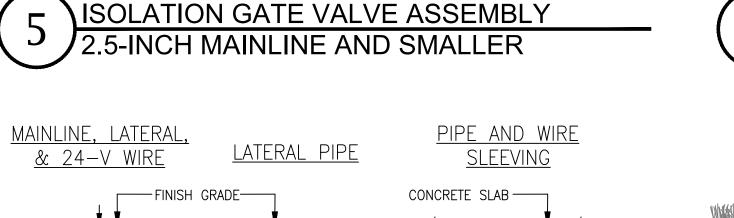
SHEET TITLE **IRRIGATION PLAN**

SHEET NUMBER IR-1.2 DRAW / REVISION


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DM/MT	REVISIONS	04AUG2023



NOTES: 1. NOMINAL SIZE OF GATE VALVE TO MATCH NOMINAL MAINLINE SIZE.



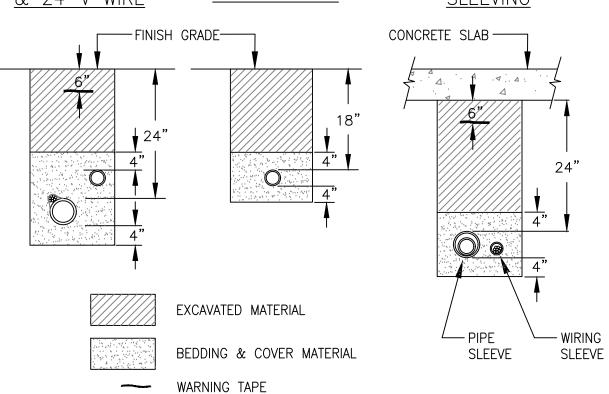PVC T.O.E. NIPPLE



NOTES:

1. SLEEVE ALL PIPE AND WIRE SEPARATELY. 2. ALL PIPE TO BE INSTALLED PER MANUFACTURER'S SPECIFICATIONS."SNAKE" UNSLEEVED PLASTIC PIPE IN TRENCH. PROVIDE A MINIMUM OF 2" CLEARANCE TO SIDE OF TRENCH AND BETWEEN PIPES.

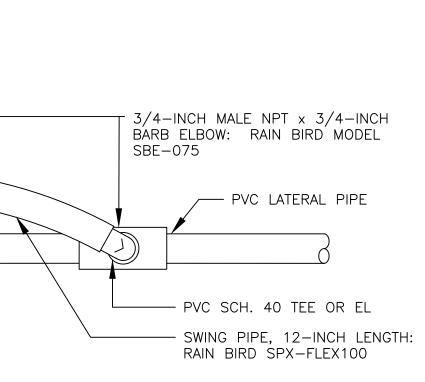
3. ALL 120-V WIRING SHALL BE INSTALLED IN ACCORDANCE WITH LOCAL CODE REQUIREMENTS. PROVIDE LOOSE 20" LOOP OF 2-WIRE CABLE AT ALL CHANGES OF DIRECTION OVER 30 DEGREES.





NOTES:

1. INSTALL PLASTIC RISERS FOR ROTORS IN NATIVE AREAS.



POP-UP ROTOR SPRINKLER:

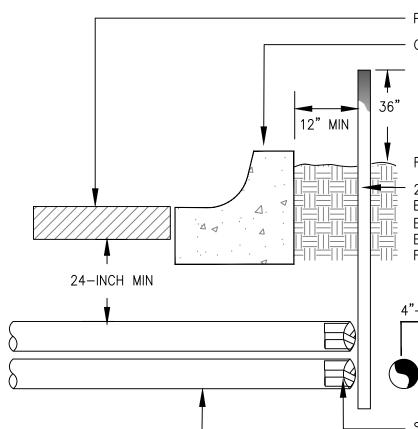
WITH CHECK VALVE. SEE LEGEND

- FINISH GRADE

FOR MODEL

QUICK COUPLING VALVE ASSEMBLY

 VALVE BOX WITH COVER: CARSON 910–4. BRAND LID WITH VALVE "QC"
FINISH GRADE
 QUICK COUPLING VALVE PER LEGEND
 STAINLESS STEEL HOSE CLAMP (1 OF 2)
 36-INCH No. 6 EPOXY COATED REBAR
 3-INCH DEPTH OF 3/4-INCH WASHED GRAVEL BRICK (1 OF 2) SCH 80 PVC NIPPLE, TOE (LENGTH VARIES) PRE-FABRICATED SWING JOINT:
SPEARS 5815-010-10
PVC MAINLINE PIPE
SCH 40 PVC TEE OR EL WITH FPT OUTLET
 NON-WOVEN LANDSCAPE FABRIC



1) ALL SLEEVING TO BE CLASS 200 BE PVC, SIZED AS NOTED.

TYPICAL SLEEVING

12-INCH POP UP SPRAY

SPRINKLER ASSEMBL'

DETAIL

2) INSTALL SLEEVES IN SIDE-BY-SIDE CONFIGURATION WHERE MULTIPLE SLEEVES

ARE TO BE INSTALLED. SPACE SLEEVES 4" TO 6" APART. DO NOT STACK SLEEVES

FLOW SENSOR

ASSEMBLY

- SEAL ENDS OF SLEEVES WITH CLOTH DUCT TAPE (TYPICAL)

- PVC SLEEVING (TYPICAL)

SPRAY NOZZLE, PER PLAN:

- FINISH GRADE/TOP OF MULCH

REGULATING VALVE FEATURES

WITH CHECK VALVE AND PRESSURE

1/2-INCH MALE NPT x .490 INCH

✓ PVC LATERAL PIPE

BARB ELBOW: RAIN BIRD MODEL

SEE LEGEND FOR MODEL

POP-UP SPRAY BODY:

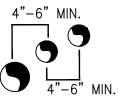
SEE LEGEND FOR MODEL

- PVC SCH. 40 TEE OR EL

RAIN BIRD SPX-FLEX100

SWING PIPE, 12-INCH LENGTH:

SBE-050



ROUGH GRADE " PVC PIPE SLEEVE MARKER: INSTALL AT BOTH ENDS OF EACH SLEEVE LOCATION AND EXTEND AT LEAST 3' ABOVE GRADE. SPRAY EXPOSED PORTION OF MARKER WITH GREEN FLUORESCENT PAINT.

- PAVED SURFACE CURB AND GUTTER IF APPLICABLE

NON-WOVEN LANDSCAPE FABRIC

→ MIN. 5 PIPE DIA.

STRAIGHT PIPE

3.0-INCH MINIMUM DEPTH OF 3/4-INCH WASHED GRAVEL

BRICK (1 OF 4)

PVC MAINLINE

- WATER PROOF CONNECTION (1 OF 5) - FLOW SENSOR: PER LEGEND

TO GROUND ROD AT THIS LOCATION. FLOW SENSOR TO DECODER CONNECTION - 2-WIRE CONNECTION TO DECODER

FINISH GRADE/TOP OF MULCH CONNECT UNUSED DECODER GROUND WIRES UNLESS CONNECTING

 $_{\infty}$ LID W/ 3-INCH HIGH LTRS.

SECURE CHRISTY ID TAG WITH NYLON ZIP TIE. LABEL WITH CONTROLLER AND FLOW SENSOR NUMBER. SENSOR DECODER: PER LEGEND VALVE BOX WITH LOCKING COVER: CARSON 1419-4B. BRAND "FM" ON

SECURE CHRISTY ID TAG WITH NYLON ZIP TIE. LABEL WITH CONTROLLER AND MASTER VALVE NUMBER. VALVE BOX WITH LOCKING COVER: CARSON 1419-4B. BRAND LID WITH "MV" (1 OF 2) (1 OF 2) LEGEND - PVC MAINLINE TO SYSTEM BRICK (1 OF 4) 80 T.O.E. NIPPLE

CONTROLLER)

NON-WOVEN LANDSCAPE FABRIC

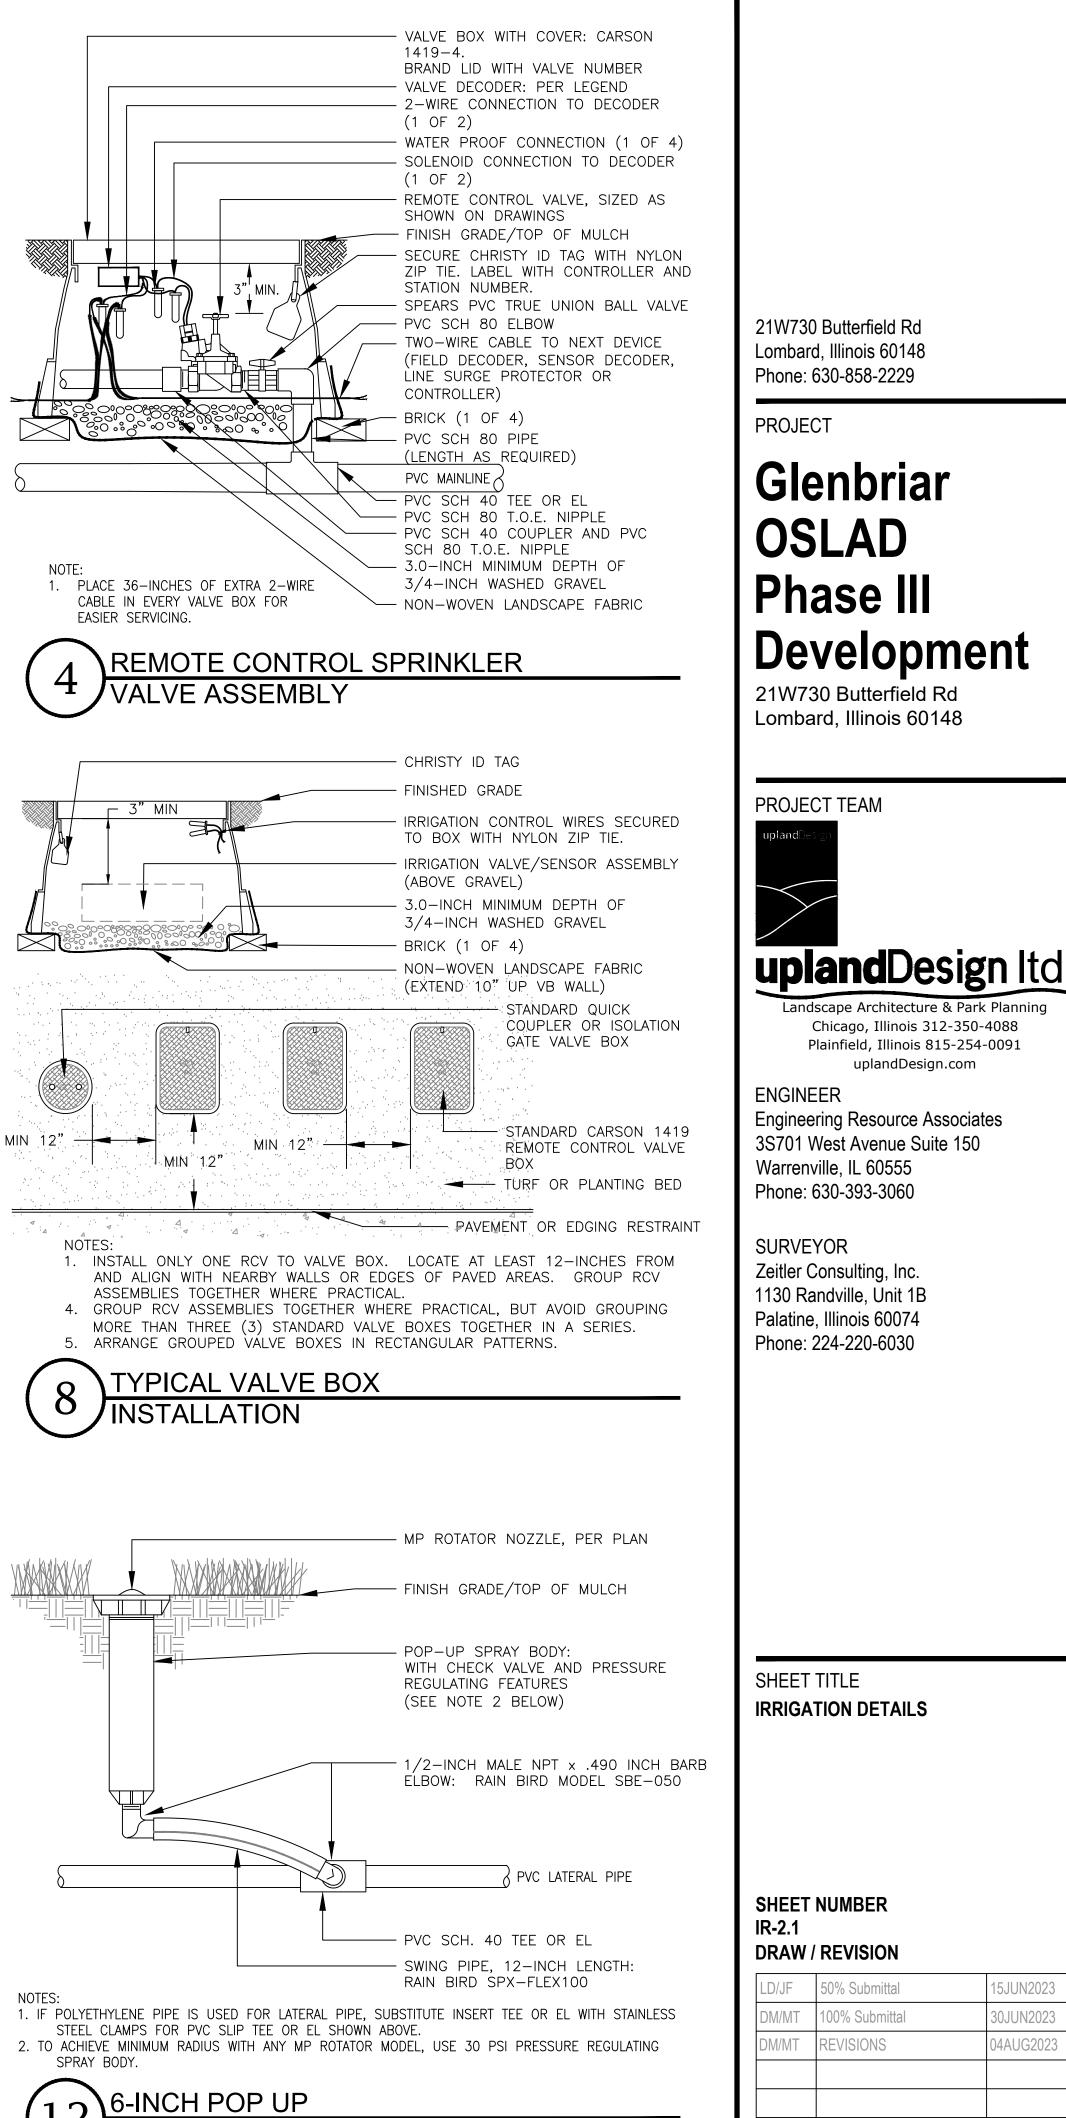
- FINISH GRADE/TOP OF MULCH - 2-WIRE CONNECTION TO DECODER - VALVE DECODER: PER LEGEND WATER PROOF CONNECTION (1 OF 4) SOLENOID CONNECTION TO DECODER MASTER VALVE, SIZE AND MODEL PER 3.0-INCH MINIMUM DEPTH OF 3/4-INCH WASHED GRAVEL PIPF DIA. -----STRAIGHT PI - PVC SCH 40 COUPLER AND PVC SCH TWO-WIRE CABLE TO NEXT DEVICE (FIELD DECODER, SENSOR DECODER, LINE SURGE PROTECTOR OR

3

NOTE

VERTICALLY.

7




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MP-ROTATOR ASSEMBLY




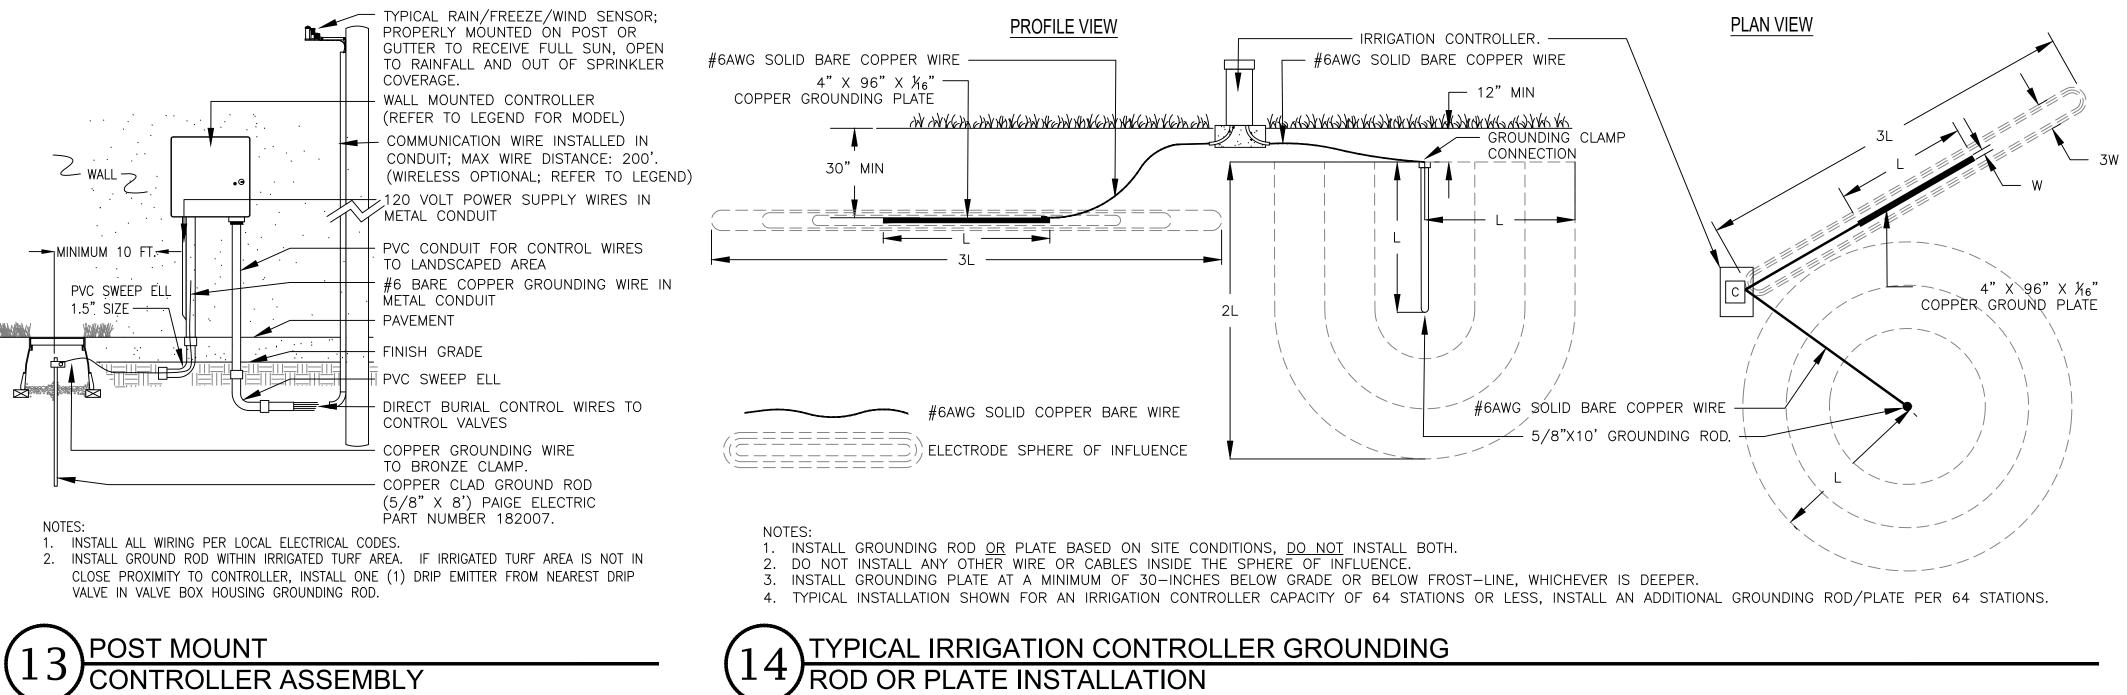
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