

LOCATION MAP

SCALE: not to scale



Landscape Architecture & Park Planning
1229 N. North Branch St, #220A, Chicago, IL 60642
24042 Lockport St, Plainfield, IL 60544
312-350-4088 | 815-254-0091 uplandDesign.com

IL License 060-007797

CIVIL ENGINEERING:



Engineering Resource Associates 3s701 West Avenue, Suite 150 Warrenville, IL 60555 IL License # 184-001186

SURVEYOR
JLH Land Surveying inc.
910 Geneva St.
Shorewood, Illinois 60404
Phone: 815-729-4000
ILicense: 184-007120

Glenbriar Park Phase III

21W730 Butterfield Rd, Lombard, Illinois 60148



Butterfield Park District

21W730 Butterfield Rd Lombard, IL 60148

Partially Funded by Illinois Department of Natural Resources OSLAD Grant No. OS 22-2167

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SEQUENCE

- 1. Southwest site landscape and irrigation work, restoration and any other tree planting as noted shall be completed by November 15, 2023.
- Northwest development shall be substantially completed by June 1, 2024

This project has been prepared by and reviewed by Licensed Landscape Architects Michelle A. Kelly # 157.001002

Heath A. Wright # 157.000994

Elizabeth A. Dafoe # 157.001572

| REVISIONS | |
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ORIGINAL ISSUE DATE

Issue for Permit 17JUL2023

PROJECT NUMBER **999-1117**

PROJECT NAME

Glenbriar Park Phase III

SHEET TITLE

Call Before


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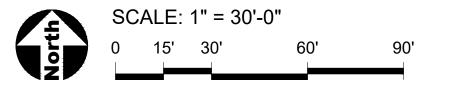
Title Sheet

SHEET NUMBER

1.0

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GENERAL NOTES: EXISTING CONDITIONS & REMOVALS

- 1. The Contractor is to locate all utilities, public and private, prior to beginning construction. Contractor will be responsible for any damages to utilities caused by their work. Contact J.U.L.I.E. 72 hours prior to construction at 1-800-982-0123 or (811) for location of utilities and contractor shall be responsible for protection of the same.
- Site conditions are shown based upon available information, contractor to verify all existing conditions prior to bidding.
- The contractor shall be responsible for the protection of all private utilities even though they may not be shown on the plans. Any utility damaged during the construction shall be repaired or replaced to the satisfaction of the Owner at the contractor's expense. No tree shall be planted within 10 lateral feet of any underground waterline, sewer line, transmission line or other utility.
- Contours and elevations shown hereon are referenced to the North American vertical datum of 1988 (navd88)
- 5. A Topographic Survey was completed for the Owner by: Zeitler Consulting Inc.

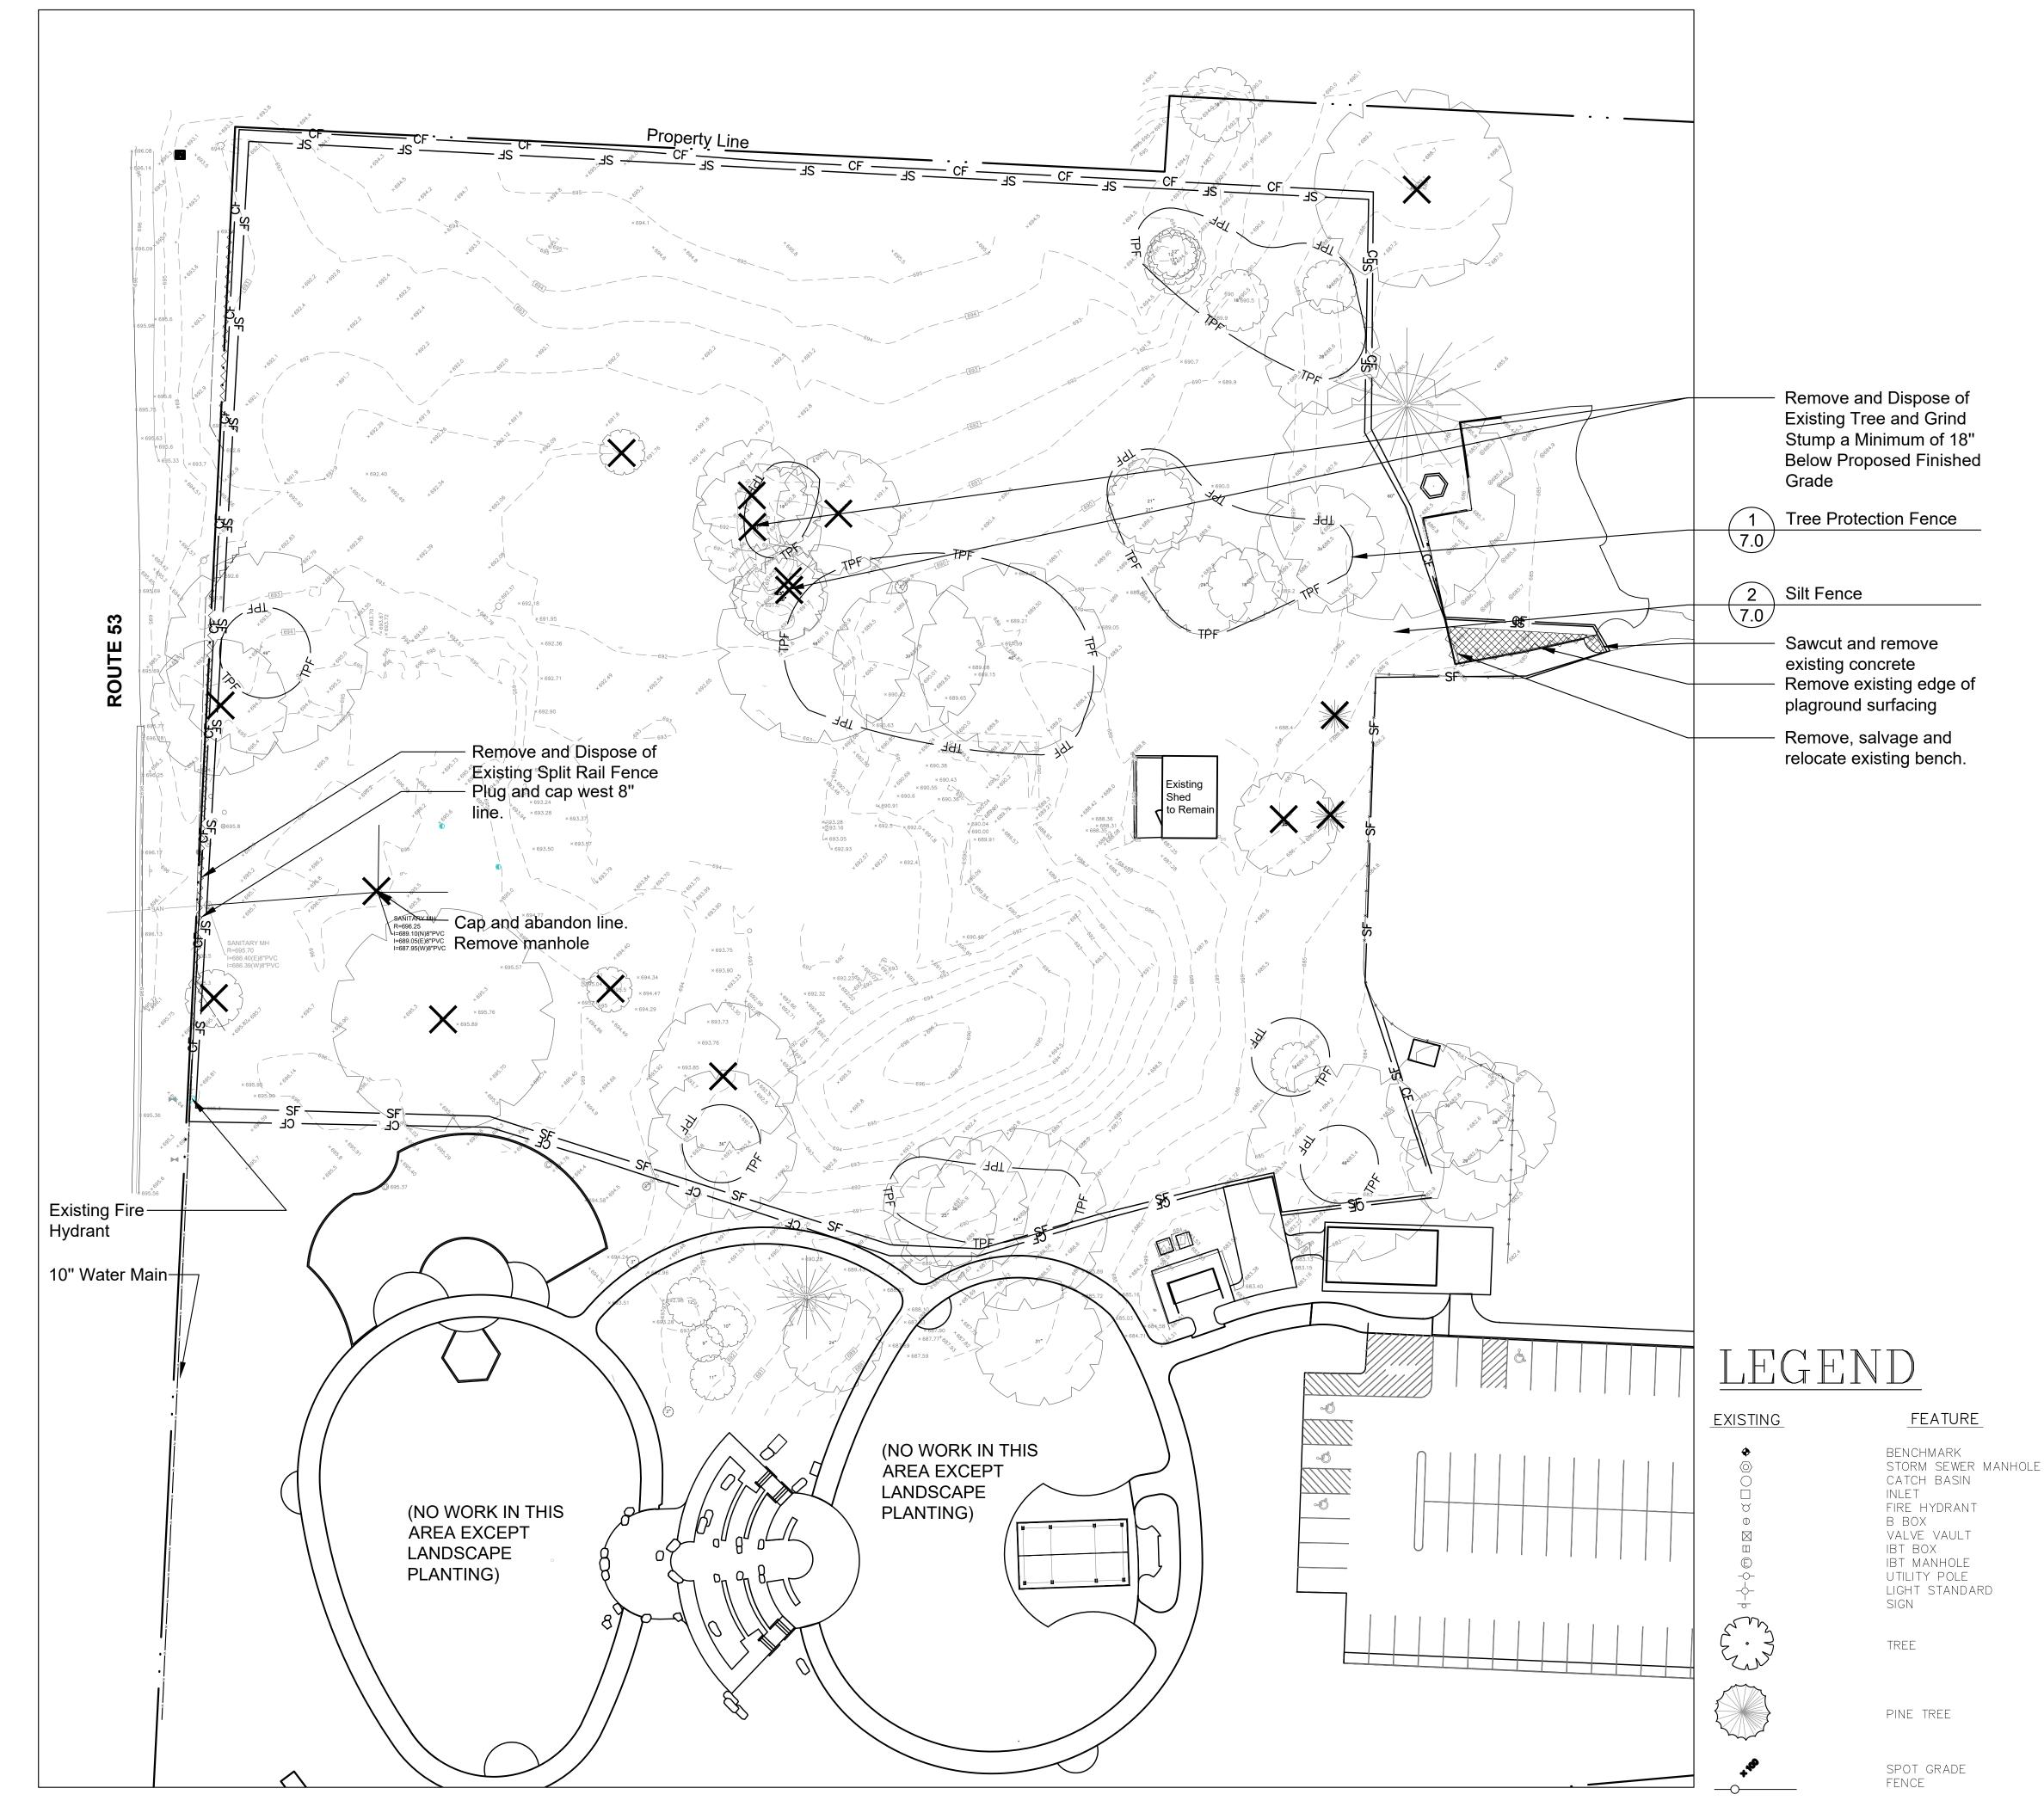1130 Randville, Unit 2B

- Palatine, Illinois 60074 Phone: 224-220-6030
- The Contractor shall walk the site prior to submitting a bid to be fully familiar with site
- The Contractor shall protect and preserve all section, property or survey reference markers. Tree Protection Fence to be installed as shown on plans and details prior to beginning construction. (incidental to cost). Do not drive, store equipment or materials within dripline of
- existing trees that are to be saved. Hold necessary disturbance to a minimum. Contractor will be held responsible for damage to items not scheduled for removal. 10. Contractor shall repair or replace all damaged sidewalks, curbs or paving to remain in place
- that were damaged as a result of work stated in contract documents. 11. No excavations are to be left open to foul weather, rain, snow, etc. which would necessitate
- further excavation and additional sub grade materials. 12. Work site safety is the responsibility of the Contractor.
- Vehicular Construction access shall be at one location to minimize damage. Construction access shall be approved by the Owner's representative.
- 14. <u>Construction Limits:</u> Construction Limits are as noted on plans. Do not store equipment or stockpile materials outside of construction limits. Any areas disturbed as a result of construction shall be restored to lawn or other surface by contractor to match pre-construction condition.
- Topsoil may be stockpiled for redistribution as needed. Excess topsoil, debris and plant material to be removed off site and disposed of legally.
- 16. Construction fence shall be installed prior to beginning construction. Construction fence to be free standing chainlink. (incidental to contract).
- 17. Place erosion control measures as required to eliminate sedimentation into non-construction
- areas and as shown on plans and details prior to beginning construction. 18. Before beginning work at the site and throughout the course of the work contractor to inspect and verify the location and condition of every item affected by the work under this contract
- and report discrepancies to the Owner's Representative before beginning work. Should discrepancies appear among the contract documents or between the contract documents and existing conditions, the contractor shall request an interpretation from the Owner's Representative before bidding. If the contractor fails to make such requests, it is presumed that both provisions were included in the bid, and the Owner's Representative shall determine which of the conflicting requirements shall govern. The contractor shall perform the work at no additional cost to the Owner in accordance with the Owner's
- Representative determination. Where conflicts exists between or within the contract documents between and applicable standards, codes, ordinances or manufacturers recommendations, and clarification has not been requested from the Owner's Representative prior to bidding as provided for above, the more stringent or higher quality standard shall prevail. Large scale drawings shall take precedence over small scale drawings, figured dimensions on the drawings over scaled dimensions and noted material over graphic representations.
- The contractor shall provide all work and materials which any section or part of the drawings, specifications or conditions require them to provide, regardless of whether such requirement is or is not faithfully repeated in other parts of the documents thereof to which the provisions might be appropriate.
- 21. All necessary site work permits will be obtained by Owner. Contractor and all subcontractors shall register and pay associated fees to the Building Department. Contractor is responsible for following permit requirements including coordination of inspections and/or reinspections
- 22. Contractor shall follow all permit requirements as part of the project.

PROJECT BENCHMARK

DUPAGE COUNTY AREA BENCHMARK:

SITE BENCHMARK:

IDOT BENCHMARK M125001 BRONZE DISK MONUMENT ON TOP OF CONCRETE HEADWALL AT THE SOUTHWEST CORNER OF THE ROADWAY BRIDGE OF IL-56 (BUTTERFIELD RD OVER

THE EAST BRANCH OF THE DUPAGE RIVER

CP-102 MMAG NAIL IN ASPHALT AT NORTHWEST CORNER OF PARKING LOT

ELEVATION = 683.44

ELEVATION = 681.14

REMOVALS LEGEND

Remove and Dispose of Existing Fence



Remove and properly dispose of trees, stump, and grind root mass to a depth of 18" below existing grade or proposed grade which ever is lowest unless otherwise noted on plan.



Remove and Dispose of Item as Marked

Salvage and Relocate Item as Marked



21W730 Butterfield Rd Lombard, Illinois 60148 Phone: 630-858-2229

PROJECT

Glenbriar OSLAD Phase III Development

21W730 Butterfield Rd Lombard, Illinois 60148

PROJECT TEAM



Landscape Architecture & Park Planning Chicago, Illinois 312-350-4088 Plainfield, Illinois 815-254-0091

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SURVEYOR

Zeitler Consulting, Inc. 1130 Randville, Unit 1B Palatine, Illinois 60074 Phone: 224-220-6030


SHEET TITLE

Existing Conditions & Removals Plan

SHEET NUMBER

DRAW / REVISION

LD/JF Issue for Permit 17JUL2023 Project Number 999-1117 Copyright 2023 Upland Design Ltd.

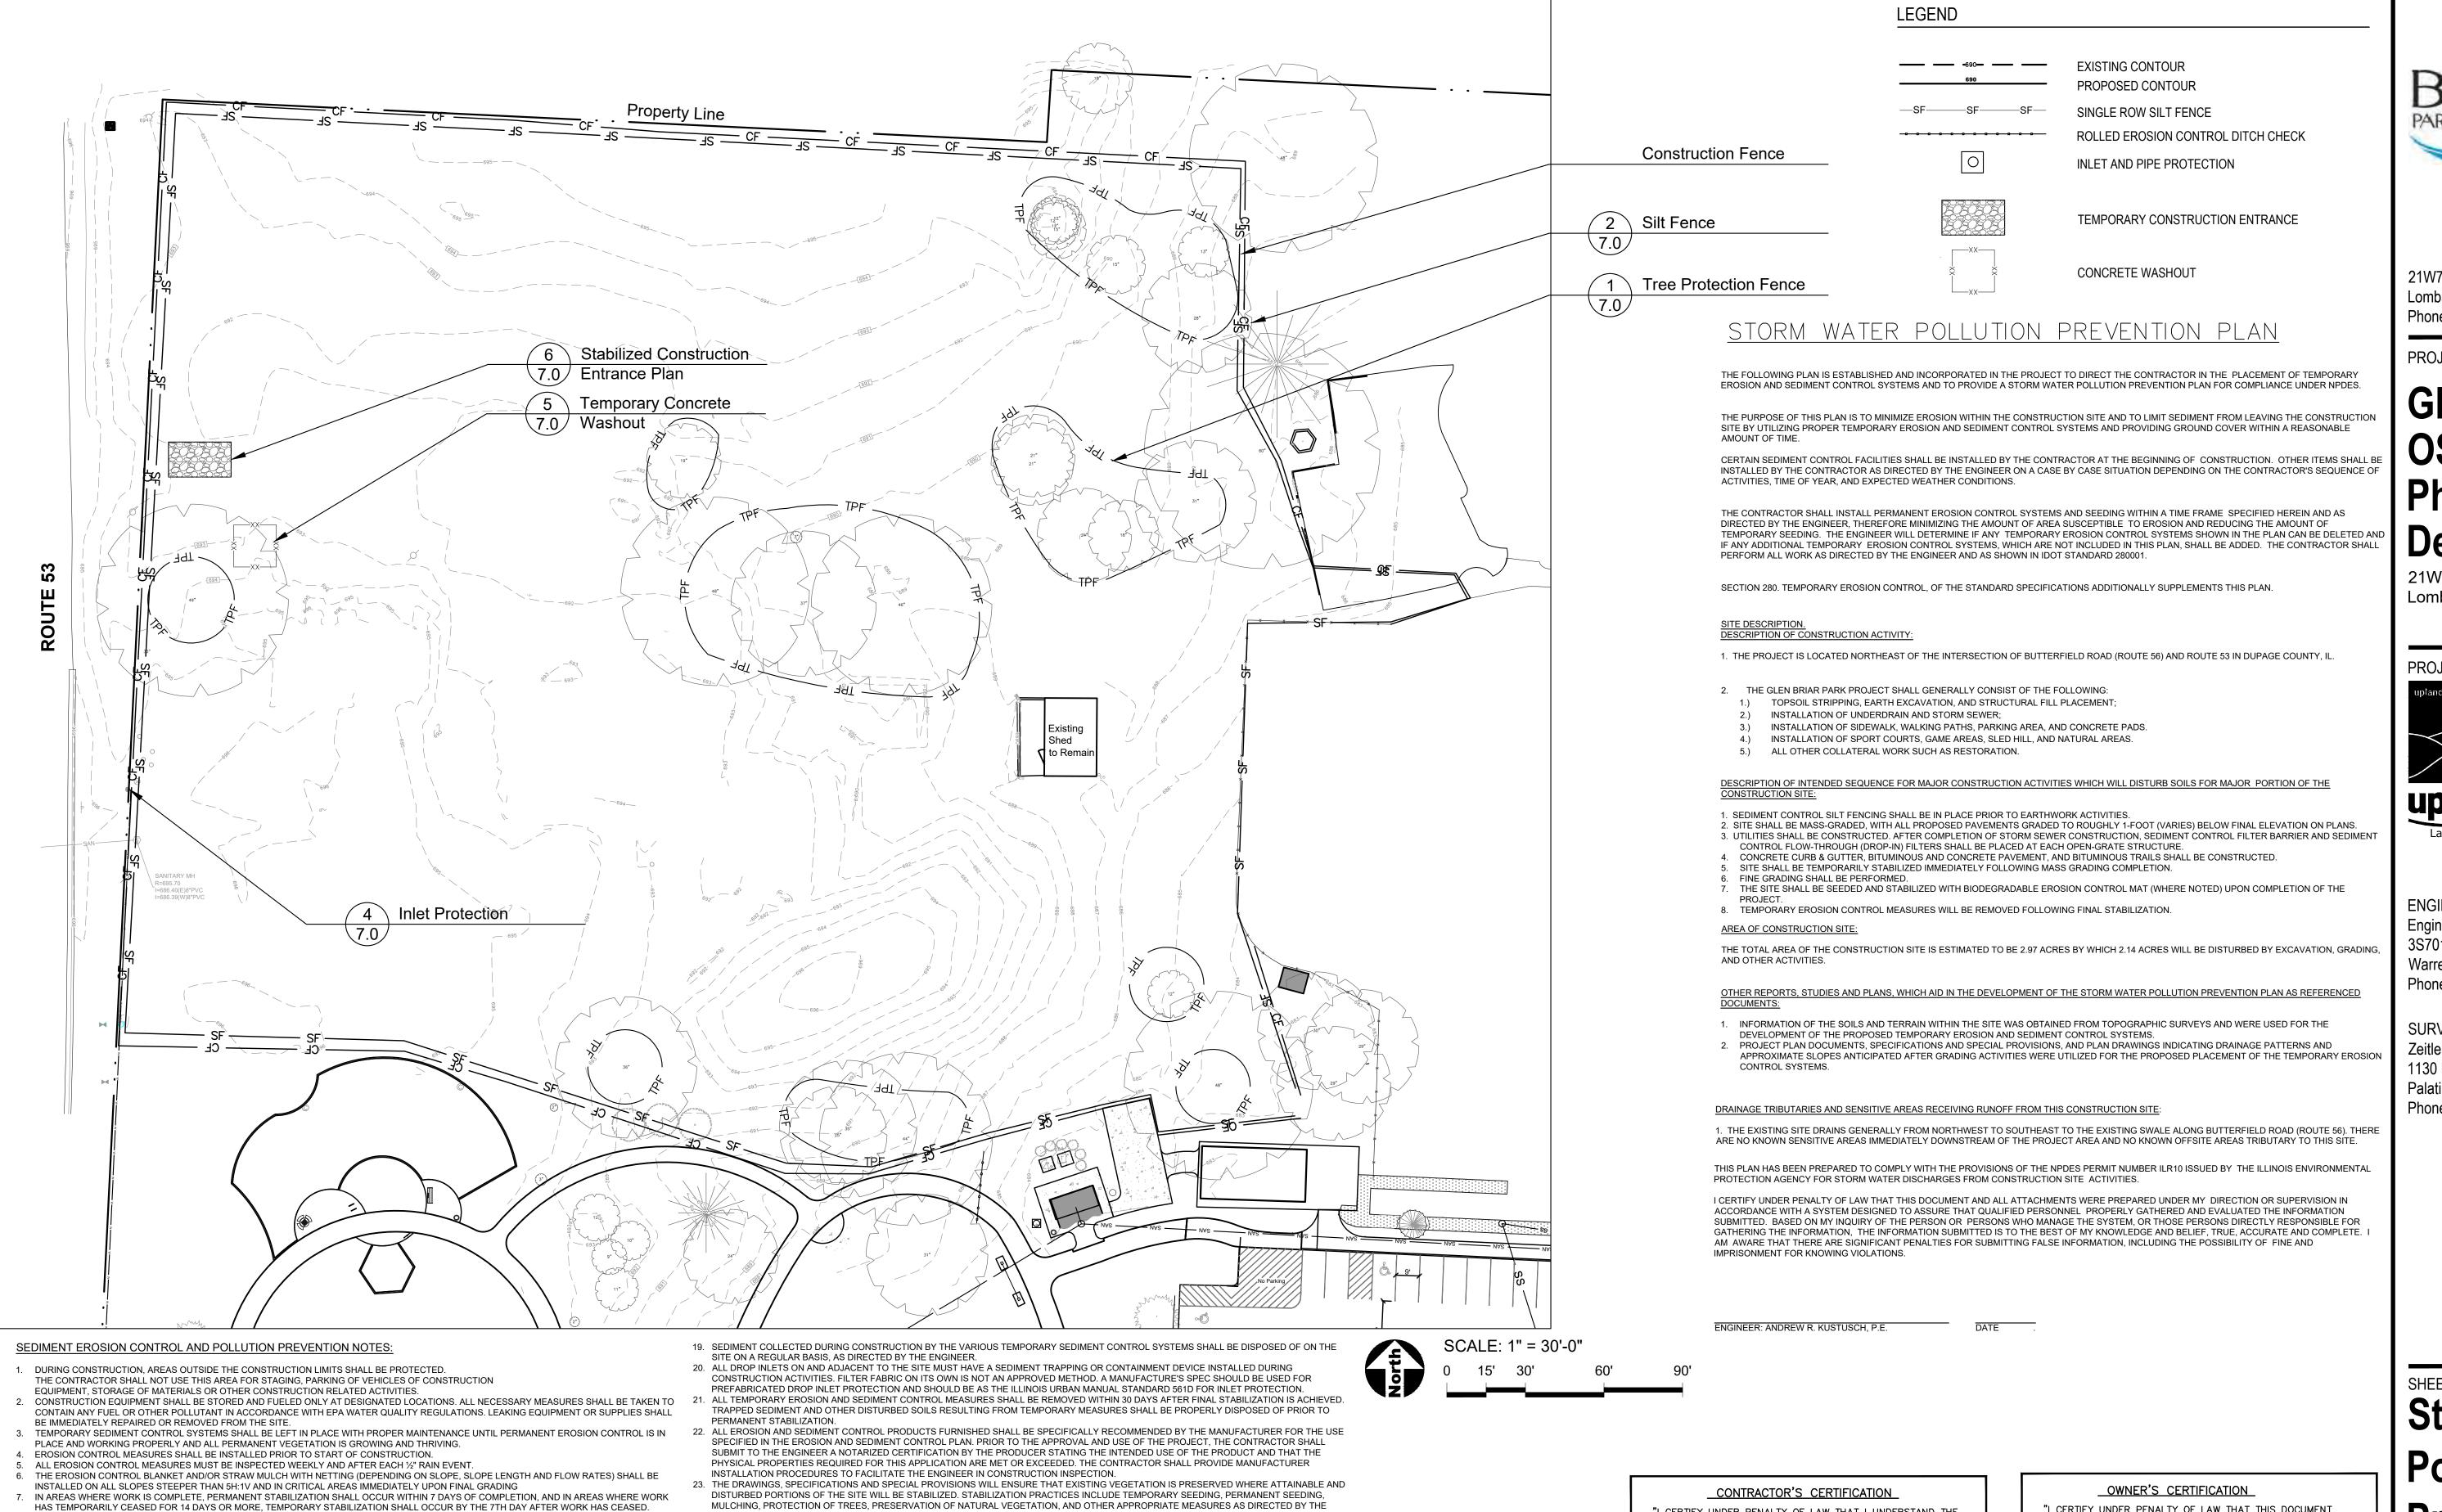

"I CERTIFY UNDER PENALTY OF LAW THAT I UNDERSTAND THE TERMS AND CONDITIONS OF THE GENERAL NATIONAL POLLUTANT DISCHARGE ELIMINATION SYSTEM (NPDES) PERMIT (ILR 10) THAT AUTHORIZES THE STORMWATER DISCHARGES ASSOCIATED WITH ACTIVITY FROM THE CONSTRUCTION SITE IDENTIFIED AS PART OF THIS CERTIFICATION. GENERAL CONTRACTOR COMPANY

"I CERTIFY UNDER PENALTY OF LAW THAT THIS DOCUMENT

AND ALL ATTACHMENTS WERE PREPARED UNDER MY DIRECTION OR SUPERVISION IN ACCORDANCE WITH A SYSTEM DESIGNED TO ASSURE THAT QUALIFIED PERSONNEL PROPERLY GATHERED AND EVALUATED THE INFORMATION SUBMITTED. BASED ON MY INQUIRY OF THE PERSON OR PERSONS WHO MANAGE THE SYSTEM, OR THOSE PERSONS DIRECTLY RESPONSIBLE FOR GATHERING THE INFORMATION, THE INFORMATION SUBMITTED IS, TO THE BEST OF MY KNOWLEDGE AND BELIEF, TRUE, ACCURATE AND COMPLETE. I AM AWARE THERE ARE SIGNIFICANT PENALTIES FOR SUBMITTING FALSE INFORMATION, INCLUDING THE POSSIBILITY OF FINE AND IMPRISONMENT FOR KNOWING VIOLATIONS."



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Glenbriar **OSLAD** Phase III Development

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SHEET TITLE

Stormwater

SHEET NUMBER

DRAW / REVISION

Project Number 999-1117

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16. EXCAVATED AREAS SHALL BE PERMANENTLY SEEDED IMMEDIATELY AFTER FINAL GRADING. IF NOT, THEY SHALL BE TEMPORARILY SEEDED IF NO

8. WINTER SHUTDOWN SHALL BE ADDRESSED EARLY IN THE FALL GROWING SEASON SO THAT SLOPES AND OTHER BARE EARTH AREAS MAY BE

9. ALL ADJACENT STREETS MUST BE KEPT CLEAR OF DEBRIS. STREETS SHALL BE INSPECTED DAILY AND CLEANED WHEN NECESSARY AND AS

10. UNLESS OTHERWISE INDICATED, ALL VEGETATIVE AND STRUCTURAL EROSION AND SEDIMENT CONTROL PRACTICES WILL BE CONSTRUCTED

12. PRIOR TO COMMENCING LAND-DISTURBING ACTIVITIES IN AREAS OTHER THAN INDICATED ON THESE PLANS (INCLUDING BUT NOT LIMITED TO,

14. DURING DEWATERING OPERATIONS (IF NECESSARY), SEDIMENT-LADEN WATER SHALL BE PUMPED INTO SEDIMENT BASINS OR SILT TRAPS.

18. STOCKPILES THAT ARE TO REMAIN IN PLACE MORE THAN THREE DAYS SHALL BE PROVIDED WITH SOIL EROSION AND SEDIMENT CONTROL

ADDITIONAL PHASES OF DEVELOPMENT AND OFF-SITE BORROW OR WASTE AREAS) A SUPPLEMENTARY EROSION CONTROL PLAN SHALL BE

13. THE CONTRACTOR IS RESPONSIBLE FOR INSTALLATION OF ANY ADDITIONAL EROSION CONTROL MEASURES NECESSARY TO PREVENT EROSION

DEWATERING SEDIMENT-LADEN WATER DIRECTLY INTO STREAMS, WETLANDS, FIELD TILES, OR STORMWATER STRUCTURES IS PROHIBITED. 15. WHERE THERE IS LOW, INTERMITTENT AMOUNTS OF DEWATERING, PUMPS WITH FILTRATION BAGS SHALL BE USED. FILTRATION BAGS SHALL BE ATTACHED TO PUMP DISCHARGES AND SURROUNDED WITH A SECONDARY CONTAINMENT OR ON A STABILIZED AREA. FILTER BAGS SHALL NOT BE

PLACED, WHOLE OR PARTIALLY, WITHIN AQUATIC AREAS (WETLANDS, PONDS, ETC.) THE MATERIAL FOR THE FILTRATION BAG SHALL MEET THE REQUIREMENTS OF MATERIAL SPECIFICATION 592 GEOTEXTILE OF THE ILLINOIS URBAN MANUAL, TABLE 2, CLASS I WITH A MINIMUM TENSILE

STRENGTH OF 200 LBS. THE FILTRATION BAG SHALL BE SIZED PER MANUFACTURER RECOMMENDATIONS AND BASED ON THE SIZE OF THE PUMP.

ACCORDING TO MINIMUM STANDARDS AND SPECIFICATIONS IN THE MOST RECENT EDITION OF THE ILLINOIS URBAN MANUAL AND IN THE DUPAGE

STABILIZED WITH TEMPORARY AND/OR PERMANENT VEGETATIVE COVER FOR PROPER EROSION AND SEDIMENT CONTROL

11. A COPY OF THE APPROVED EROSION AND SEDIMENT CONTROL PLAN SHALL BE MAINTAINED ON THE SITE AT ALL TIMES.

DIRECTED BY ENGINEER

COUNTY CODE OF ORDINANCES.

SUBMITTED TO THE OWNER FOR REVIEW BY THE ENGINEER.

CONSTRUCTION ACTIVITY IN THE AREA IS PLANNED FOR SEVEN (7) DAYS.

17. TEMPORARY EROSION CONTROL SEEDING SHALL BE APPLIED AT A RATE OF 100 LBS/ACRES.

AND SEDIMENTATION AS DETERMINED BY THE ENGINEER.

MULCHING, PROTECTION OF TREES, PRESERVATION OF NATURAL VEGETATION, AND OTHER APPROPRIATE MEASURES AS DIRECTED BY THE ENGINEER. STABILIZATION MEASURES SHALL BE INITIATED AS SOON AS PRACTICABLE IN PORTIONS OF THE SITE WHERE CONSTRUCTION ACTIVITIES HAVE TEMPORARILY OR PERMANENTLY CEASED, BUT IN NO CASE MORE THAN 7 DAYS AFTER THE CONSTRUCTION ACTIVITY IN THAT PORTION OF THE SITE HAS TEMPORARILY OR PERMANENTLY CEASED.

a. AREAS OF EXISTING VEGETATION, WOOD AND GRASSLANDS, OUTSIDE THE PROPOSED CONSTRUCTION LIMITS SHALL BE SHALL BE PROTECTED FROM CONSTRUCTION ACTIVITIES b. BARE AND SPARSELY VEGETATED GROUND IN HIGH ERODIBLE AREAS AS DETERMINED BY THE ENGINEER SHALL BE TEMPORARILY SEEDED AT THE


BEGINNING OF CONSTRUCTION WHERE NO CONSTRUCTION ACTIVITIES ARE EXPECTED WITHIN SEVEN (7) DAYS. 24. THE SITE SHOULD BE PHASED IN A WAY THAT REDUCES THE AMOUNT OF STRIPPED, UNSTABILIZED AREAS WITHIN THE SITE AT ANY ONE TIME.

MASS GRADING THE ENTIRE SITE SHOULD BE AVOIDED AS TO PREVENT EROSION ON SITE AND SEDIMENTATION ISSUES DOWNSTREAM. 25. CONSTRUCTION IS COMPLETE AFTER ACCEPTANCE BY THE OWNER. MAINTENANCE UP TO THIS DATE WILL BE BY THE CONTRACTOR.

26. IT IS THE RESPONSIBILITY OF THE GENERAL CONTRACTOR TO INFORM ANY SUB-CONTRACTOR(S) WHO MAY PERFORM WORK ON THIS PROJECT, OF THE REQUIREMENTS IN IMPLEMENTING AND MAINTAINING THESE EROSION CONTROL PLANS AND ASSURE COMPLIANCE WITH ALL APPLICABLE LOCAL, STATE AND FEDERAL REGULATIONS.

"I CERTIFY UNDER PENALTY OF LAW THAT I UNDERSTAND THE TERMS AND CONDITIONS OF THE GENERAL NATIONAL POLLUTANT DISCHARGE ELIMINATION SYSTEM (NPDES) PERMIT (ILR10) THAT AUTHORIZES THE STORM WATER DISCHARGES ASSOCIATED WITH INDUSTRIAL ACTIVITY FROM THE CONSTRUCTION SITE IDENTIFIED AS PART OF THIS CERTIFICATION."

_ CONTRACTOR SIGNATURE

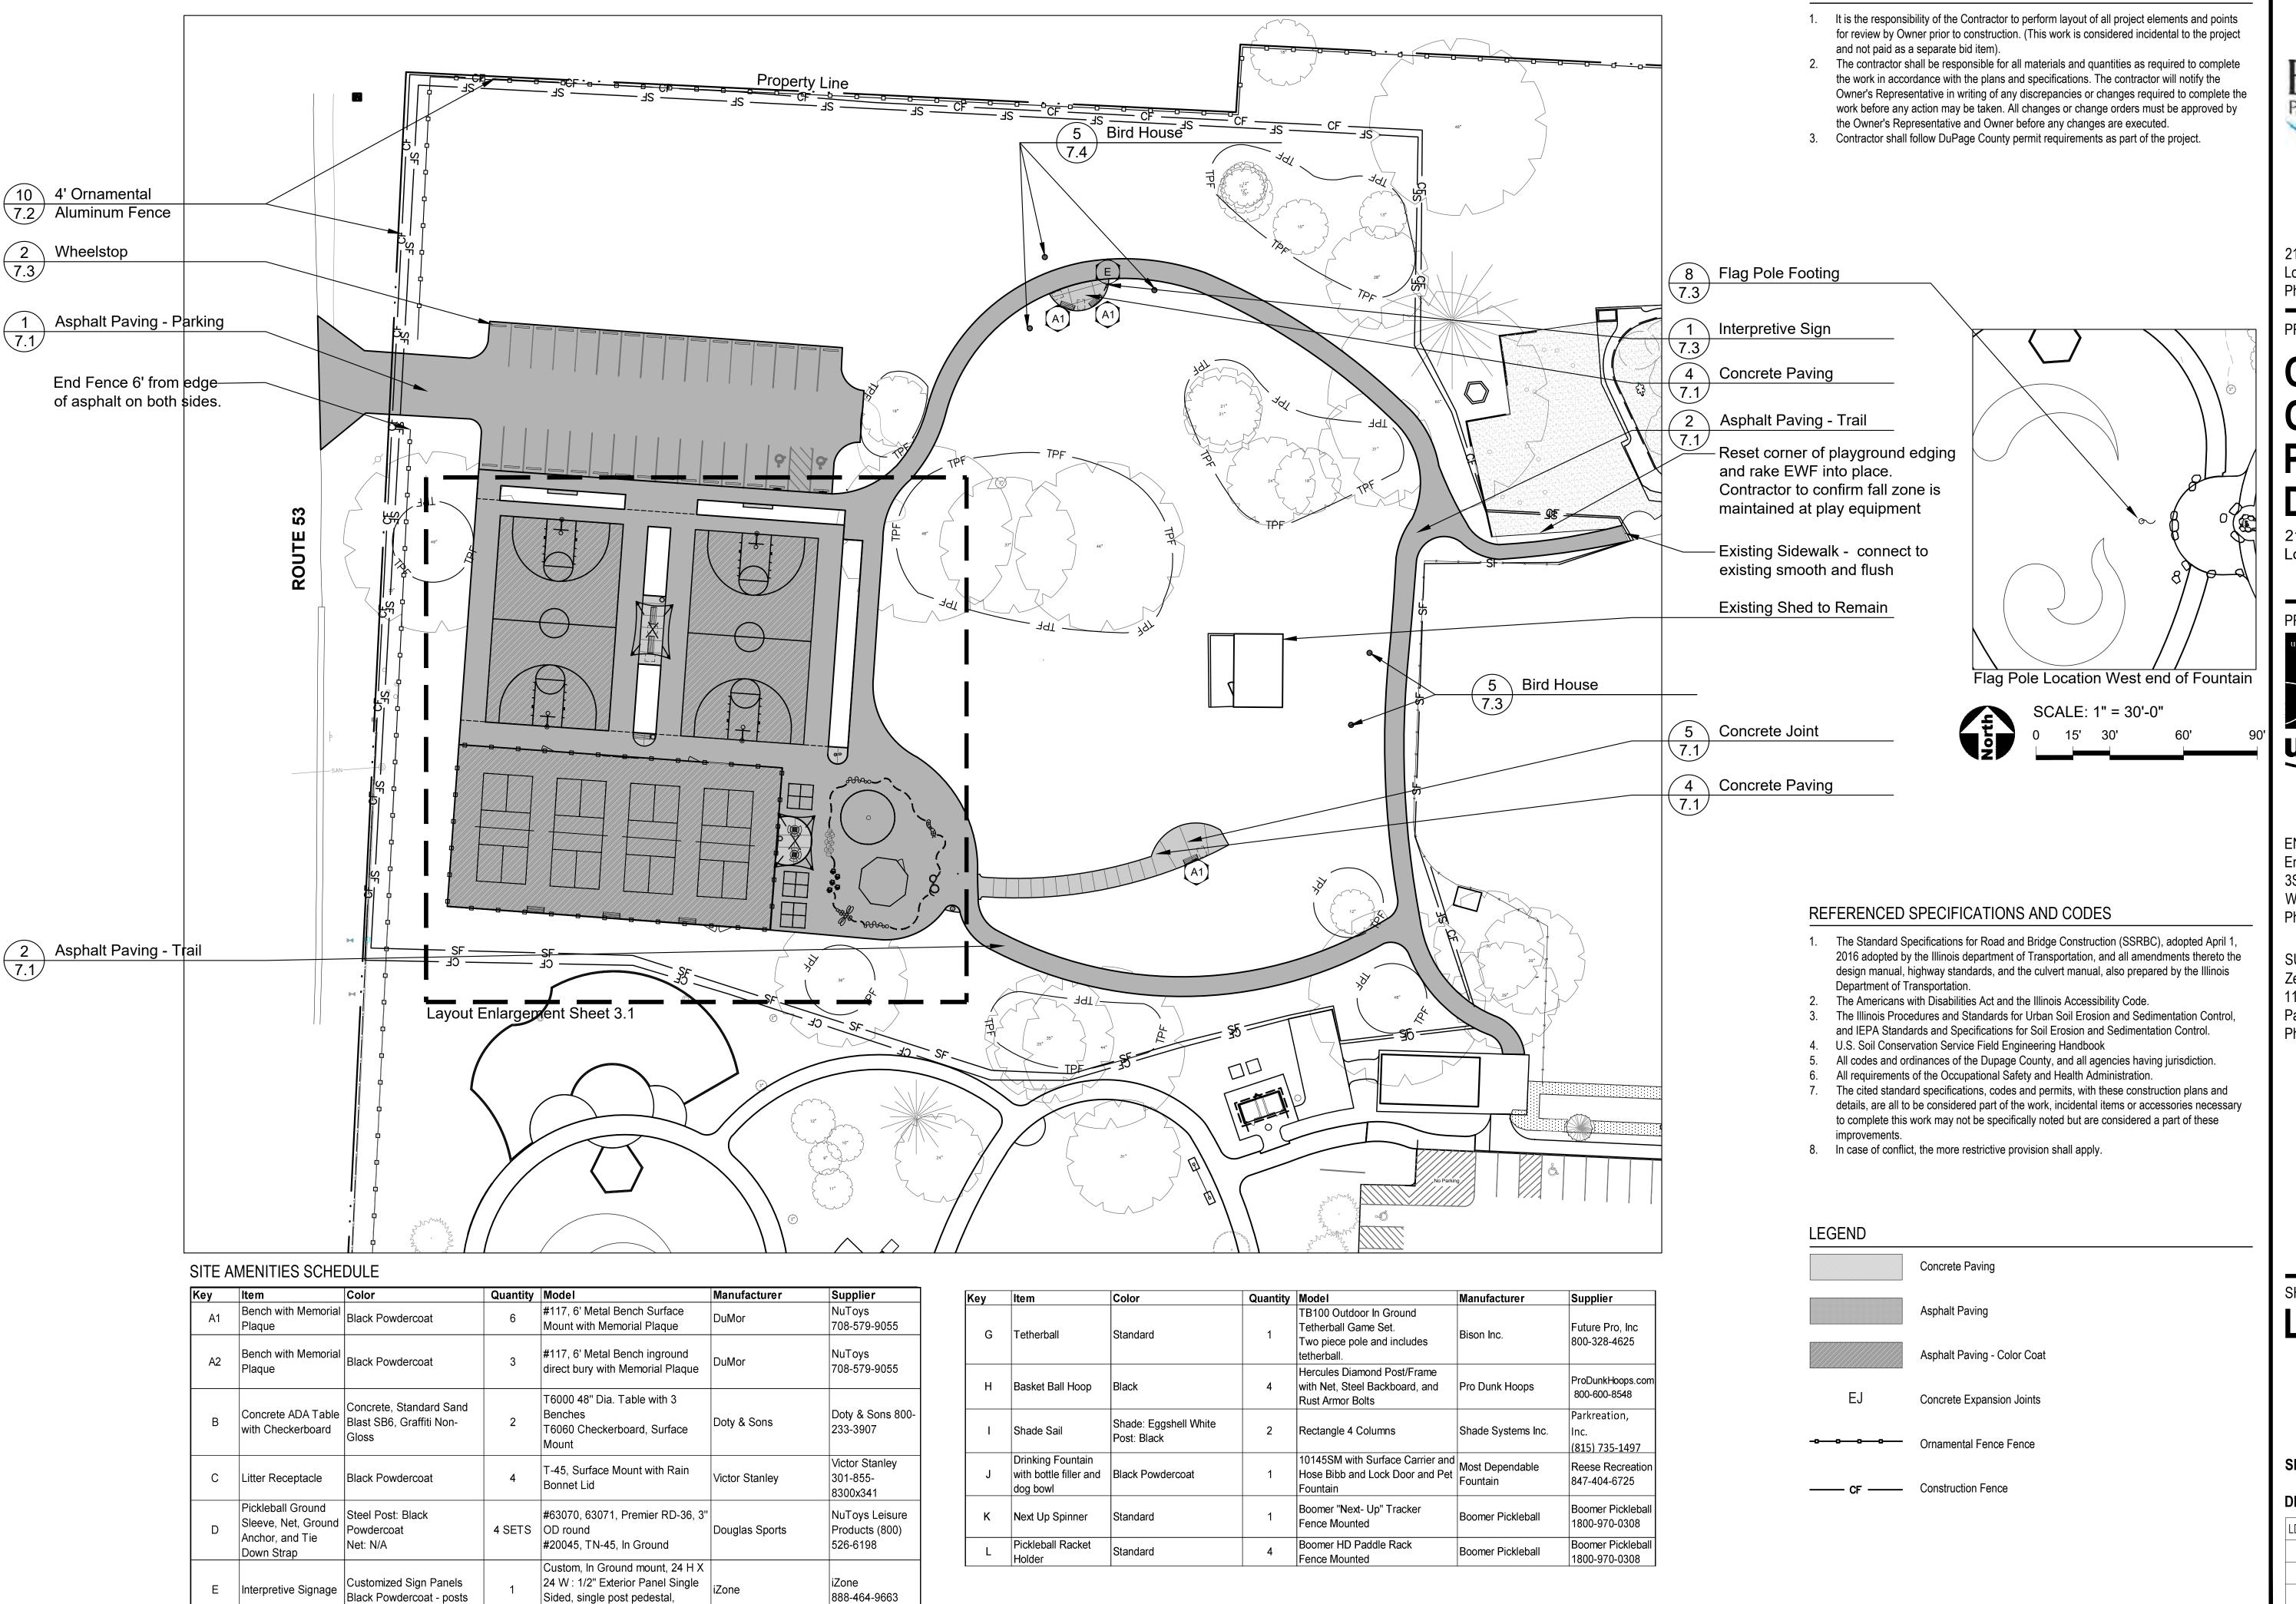

Graphics to come

Wall, Surface Mount

Composite Lumber: Brown

Wall Top and Brackets: Red

F Gaga Ball

Octagon 30H, 20' Diameter Wall-to-Coach Cliff's GaGa Ball

Coach Cliff's

GaGa Ball Pits

877-266-8426



21W730 Butterfield Rd Lombard, Illinois 60148 Phone: 630-858-2229

PROJECT

GENERAL NOTES: LAYOUT

Glenbriar OSLAD Phase III Development

21W730 Butterfield Rd Lombard, Illinois 60148

PROJECT TEAM



uplandDesign Itd

Landscape Architecture & Park Planning Chicago, Illinois 312-350-4088 Plainfield, Illinois 815-254-0091 uplandDesign.com

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SURVEYOR

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SHEET TITLE


Layout Plan

SHEET NUMBER

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| LD/JF | Issue for Permit | 17JUL2023 |
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PROJECT

Glenbriar OSLAD Phase III Development

21W730 Butterfield Rd Lombard, Illinois 60148

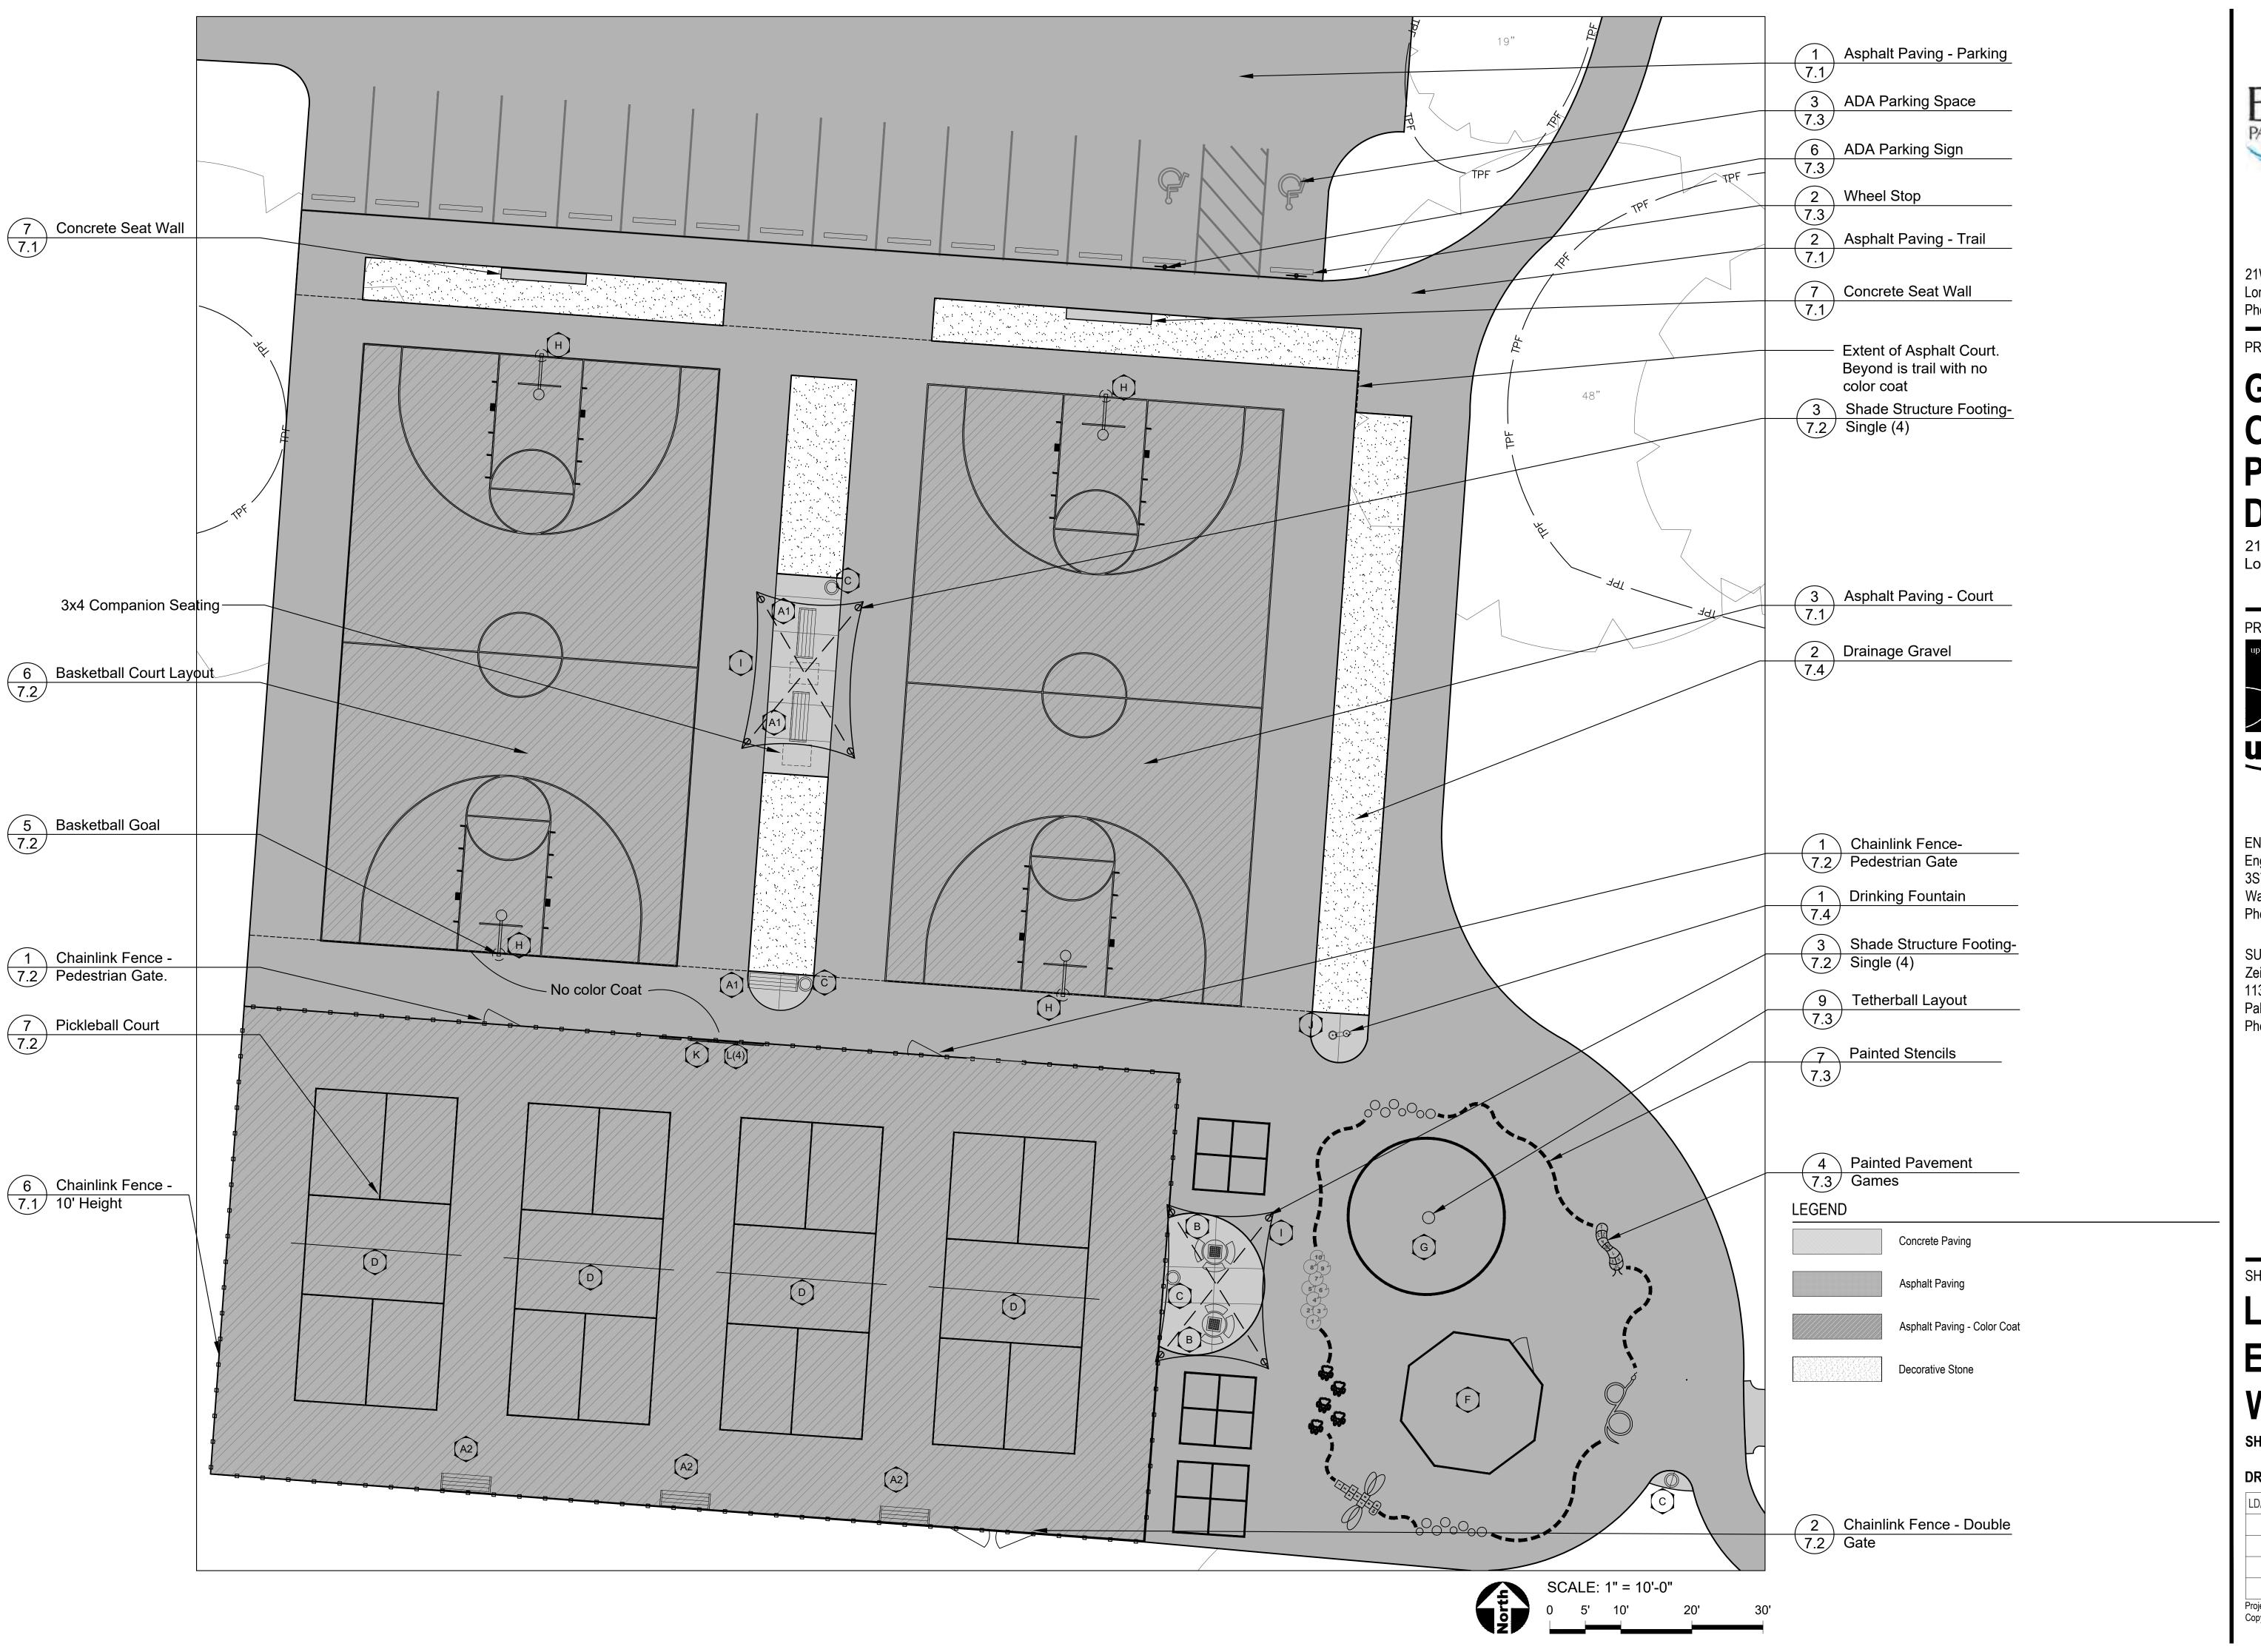PROJECT TEAM



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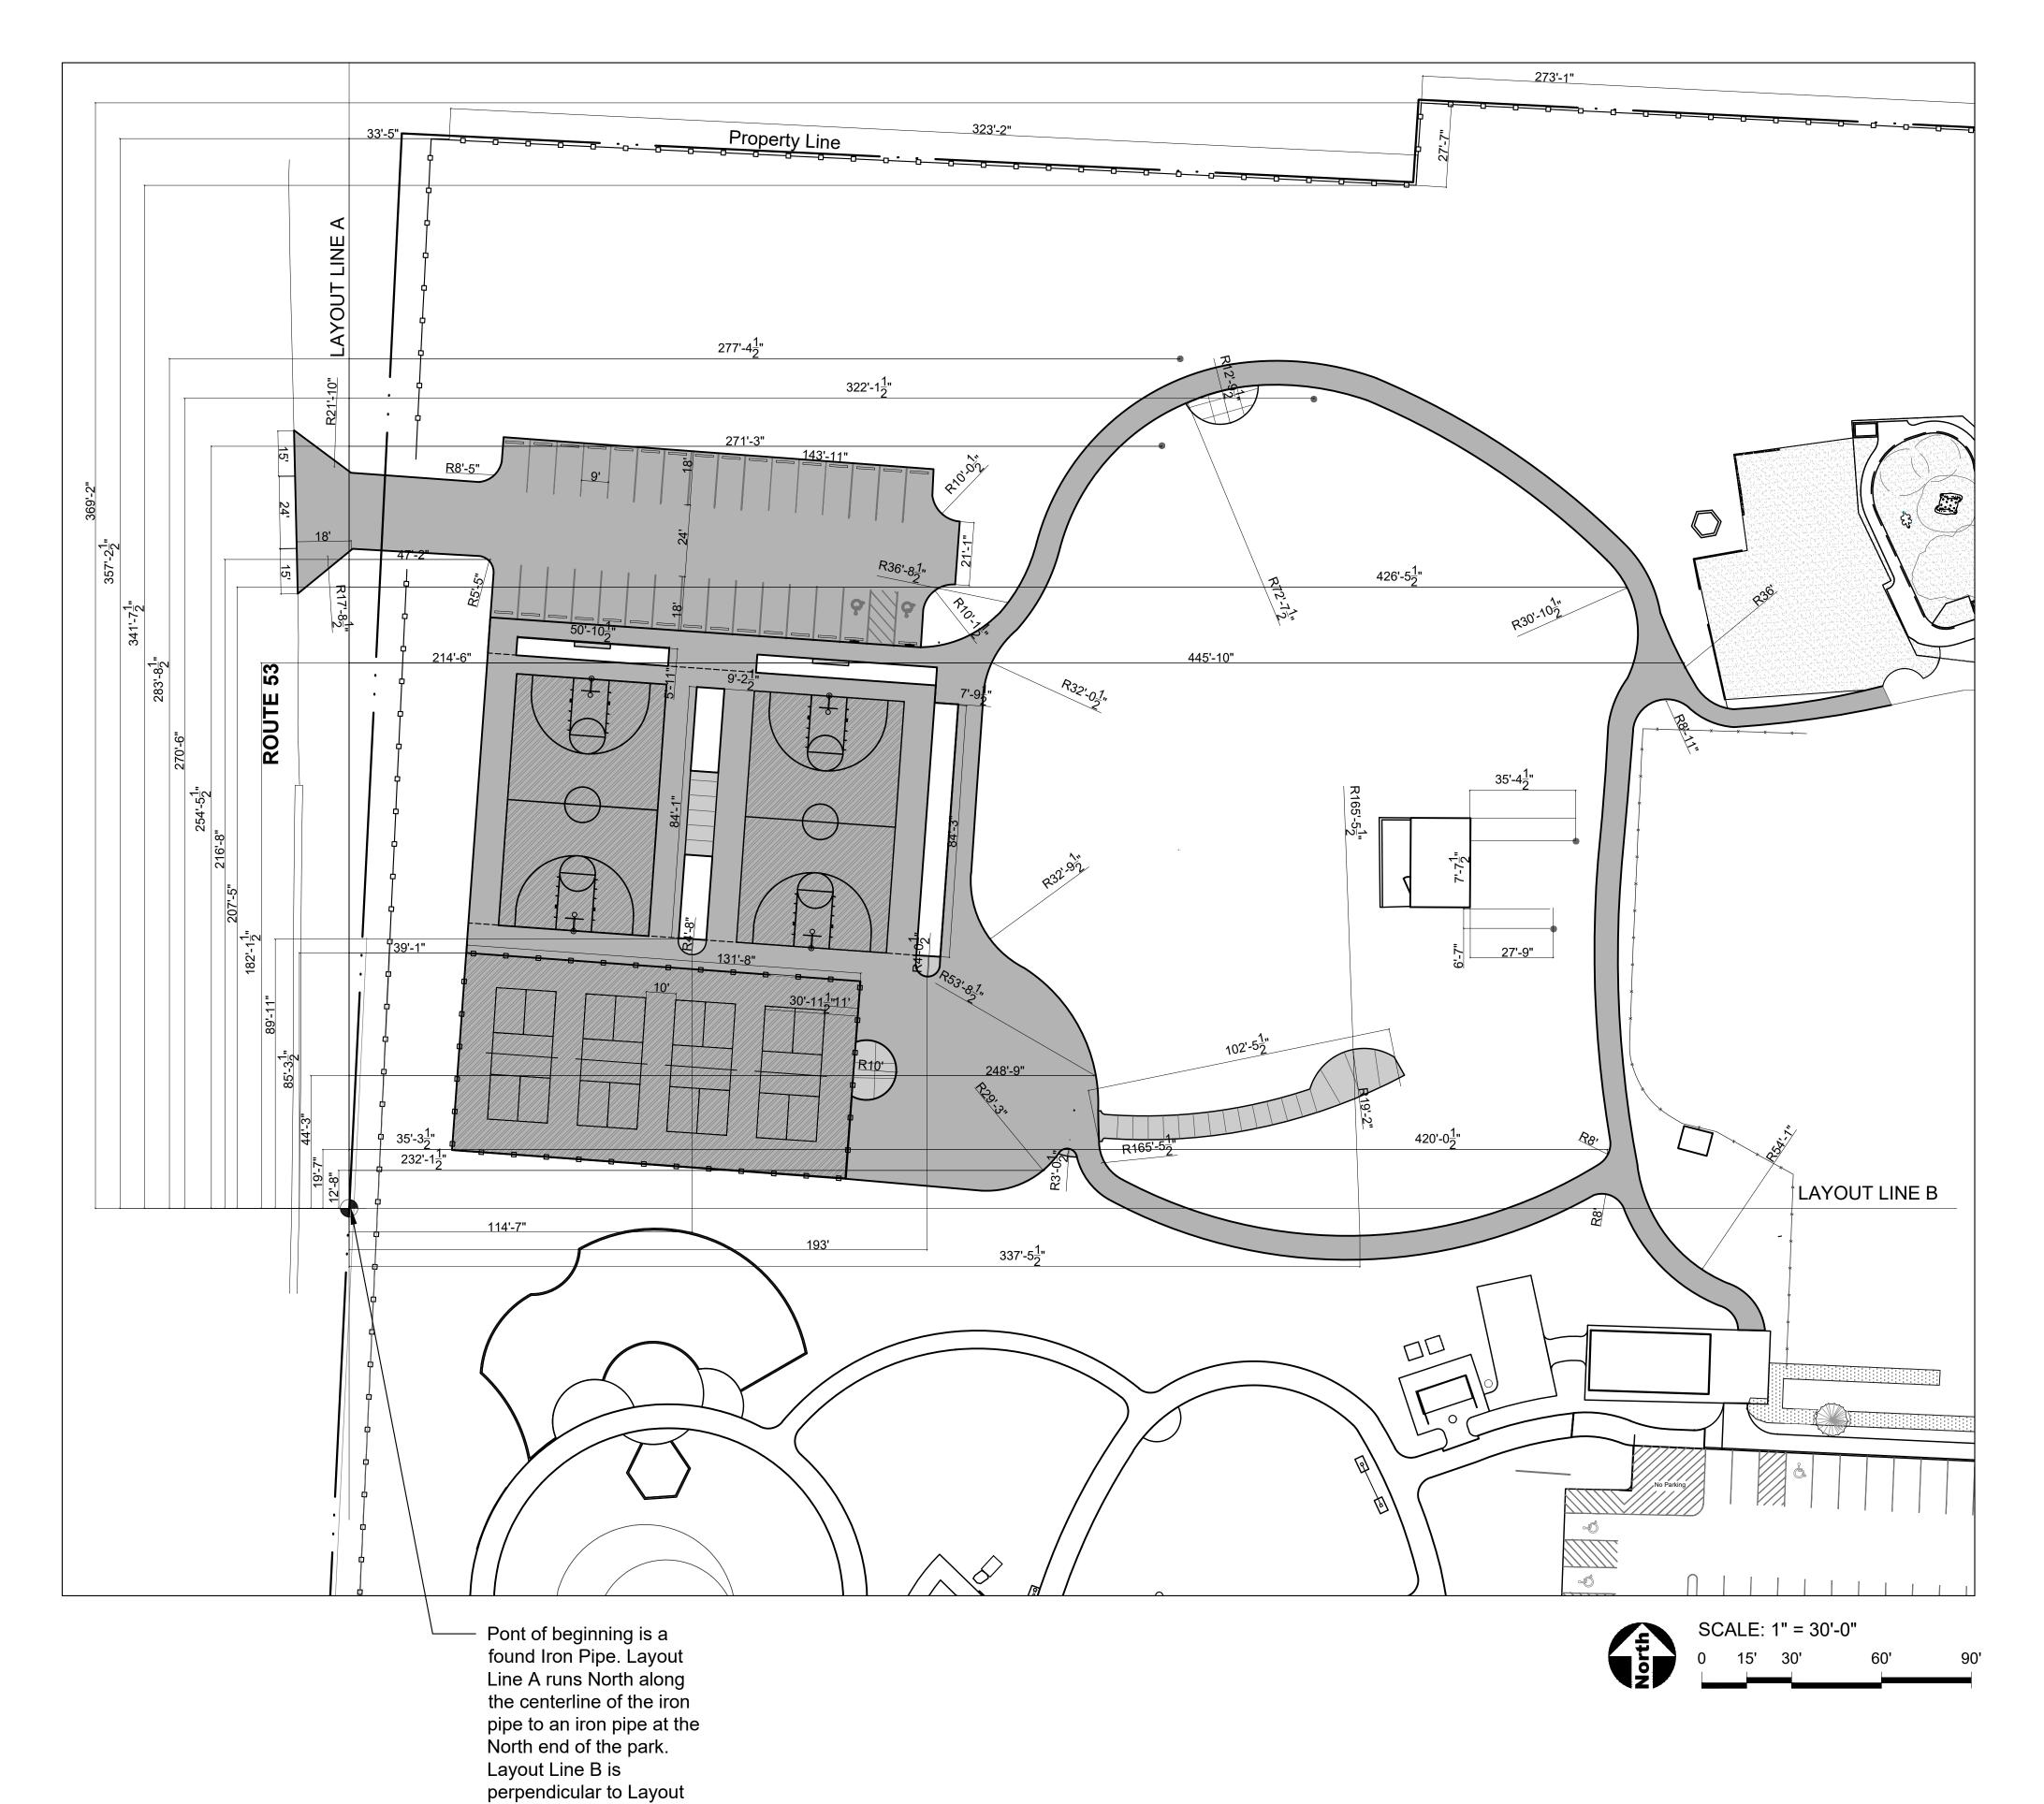
SHEET TITLE

Layout Enlargement -West

SHEET NUMBER

DRAW / REVISION

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| | 2023 Upland Design Ltd. | |



Line A.

GENERAL NOTES: DIMENSION

- Layout of equipment is to center of post.
- Layout play equipment with safety zones to be staked by the Contractor for review by Owner's Representative prior to play equipment installation.
- Paving radii shall be formed completely and shall smoothly transition into tangents and adjoining lines. Dimensions are to face of curb and edge of pavement unless otherwise
- 4. Dimensions are in feet or degrees. Dimensions are perpendicular & parallel unless otherwise
- 5. See Layout Plan, Sheet 2.0 for additional general notes and referenced specifications and
- Contractor shall perform all construction layout for the project. Contractor will be provided with an electronic file in AutoCAD format to assist with layout. Neither the Owner nor their representative shall be responsible for setting additional layout points.



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PROJECT

Glenbriar **OSLAD** Phase III Development

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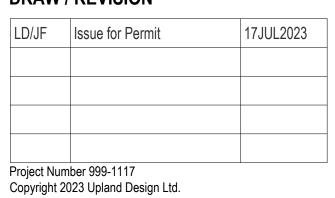
SCALE: 1" = 30'-0"

Dimension Plan - Paving **Edges**

SHEET NUMBER


SHEET TITLE

DRAW / REVISION



4.0

Flag Pole Enlargement

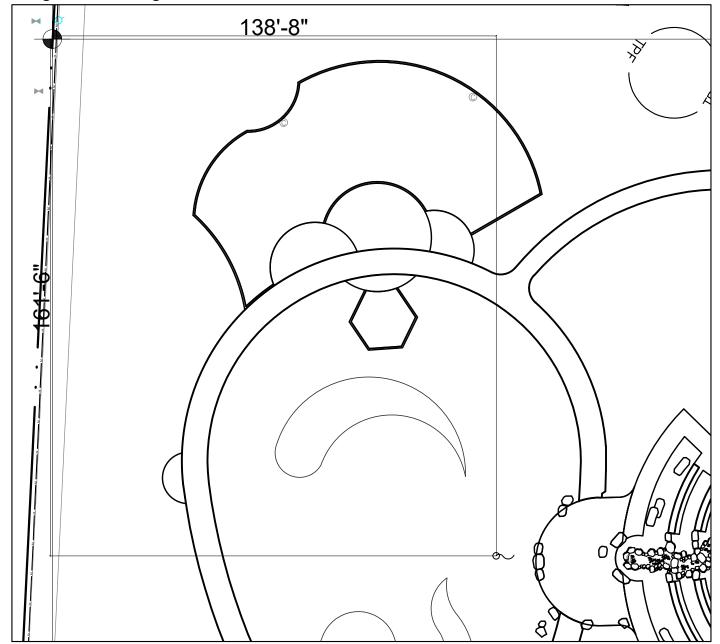

LEGEND

Concrete Paving


Asphalt Paving

Point of Beginning

Chainlink Fence

Asphalt Paving - Court

Concrete Expansion Joints

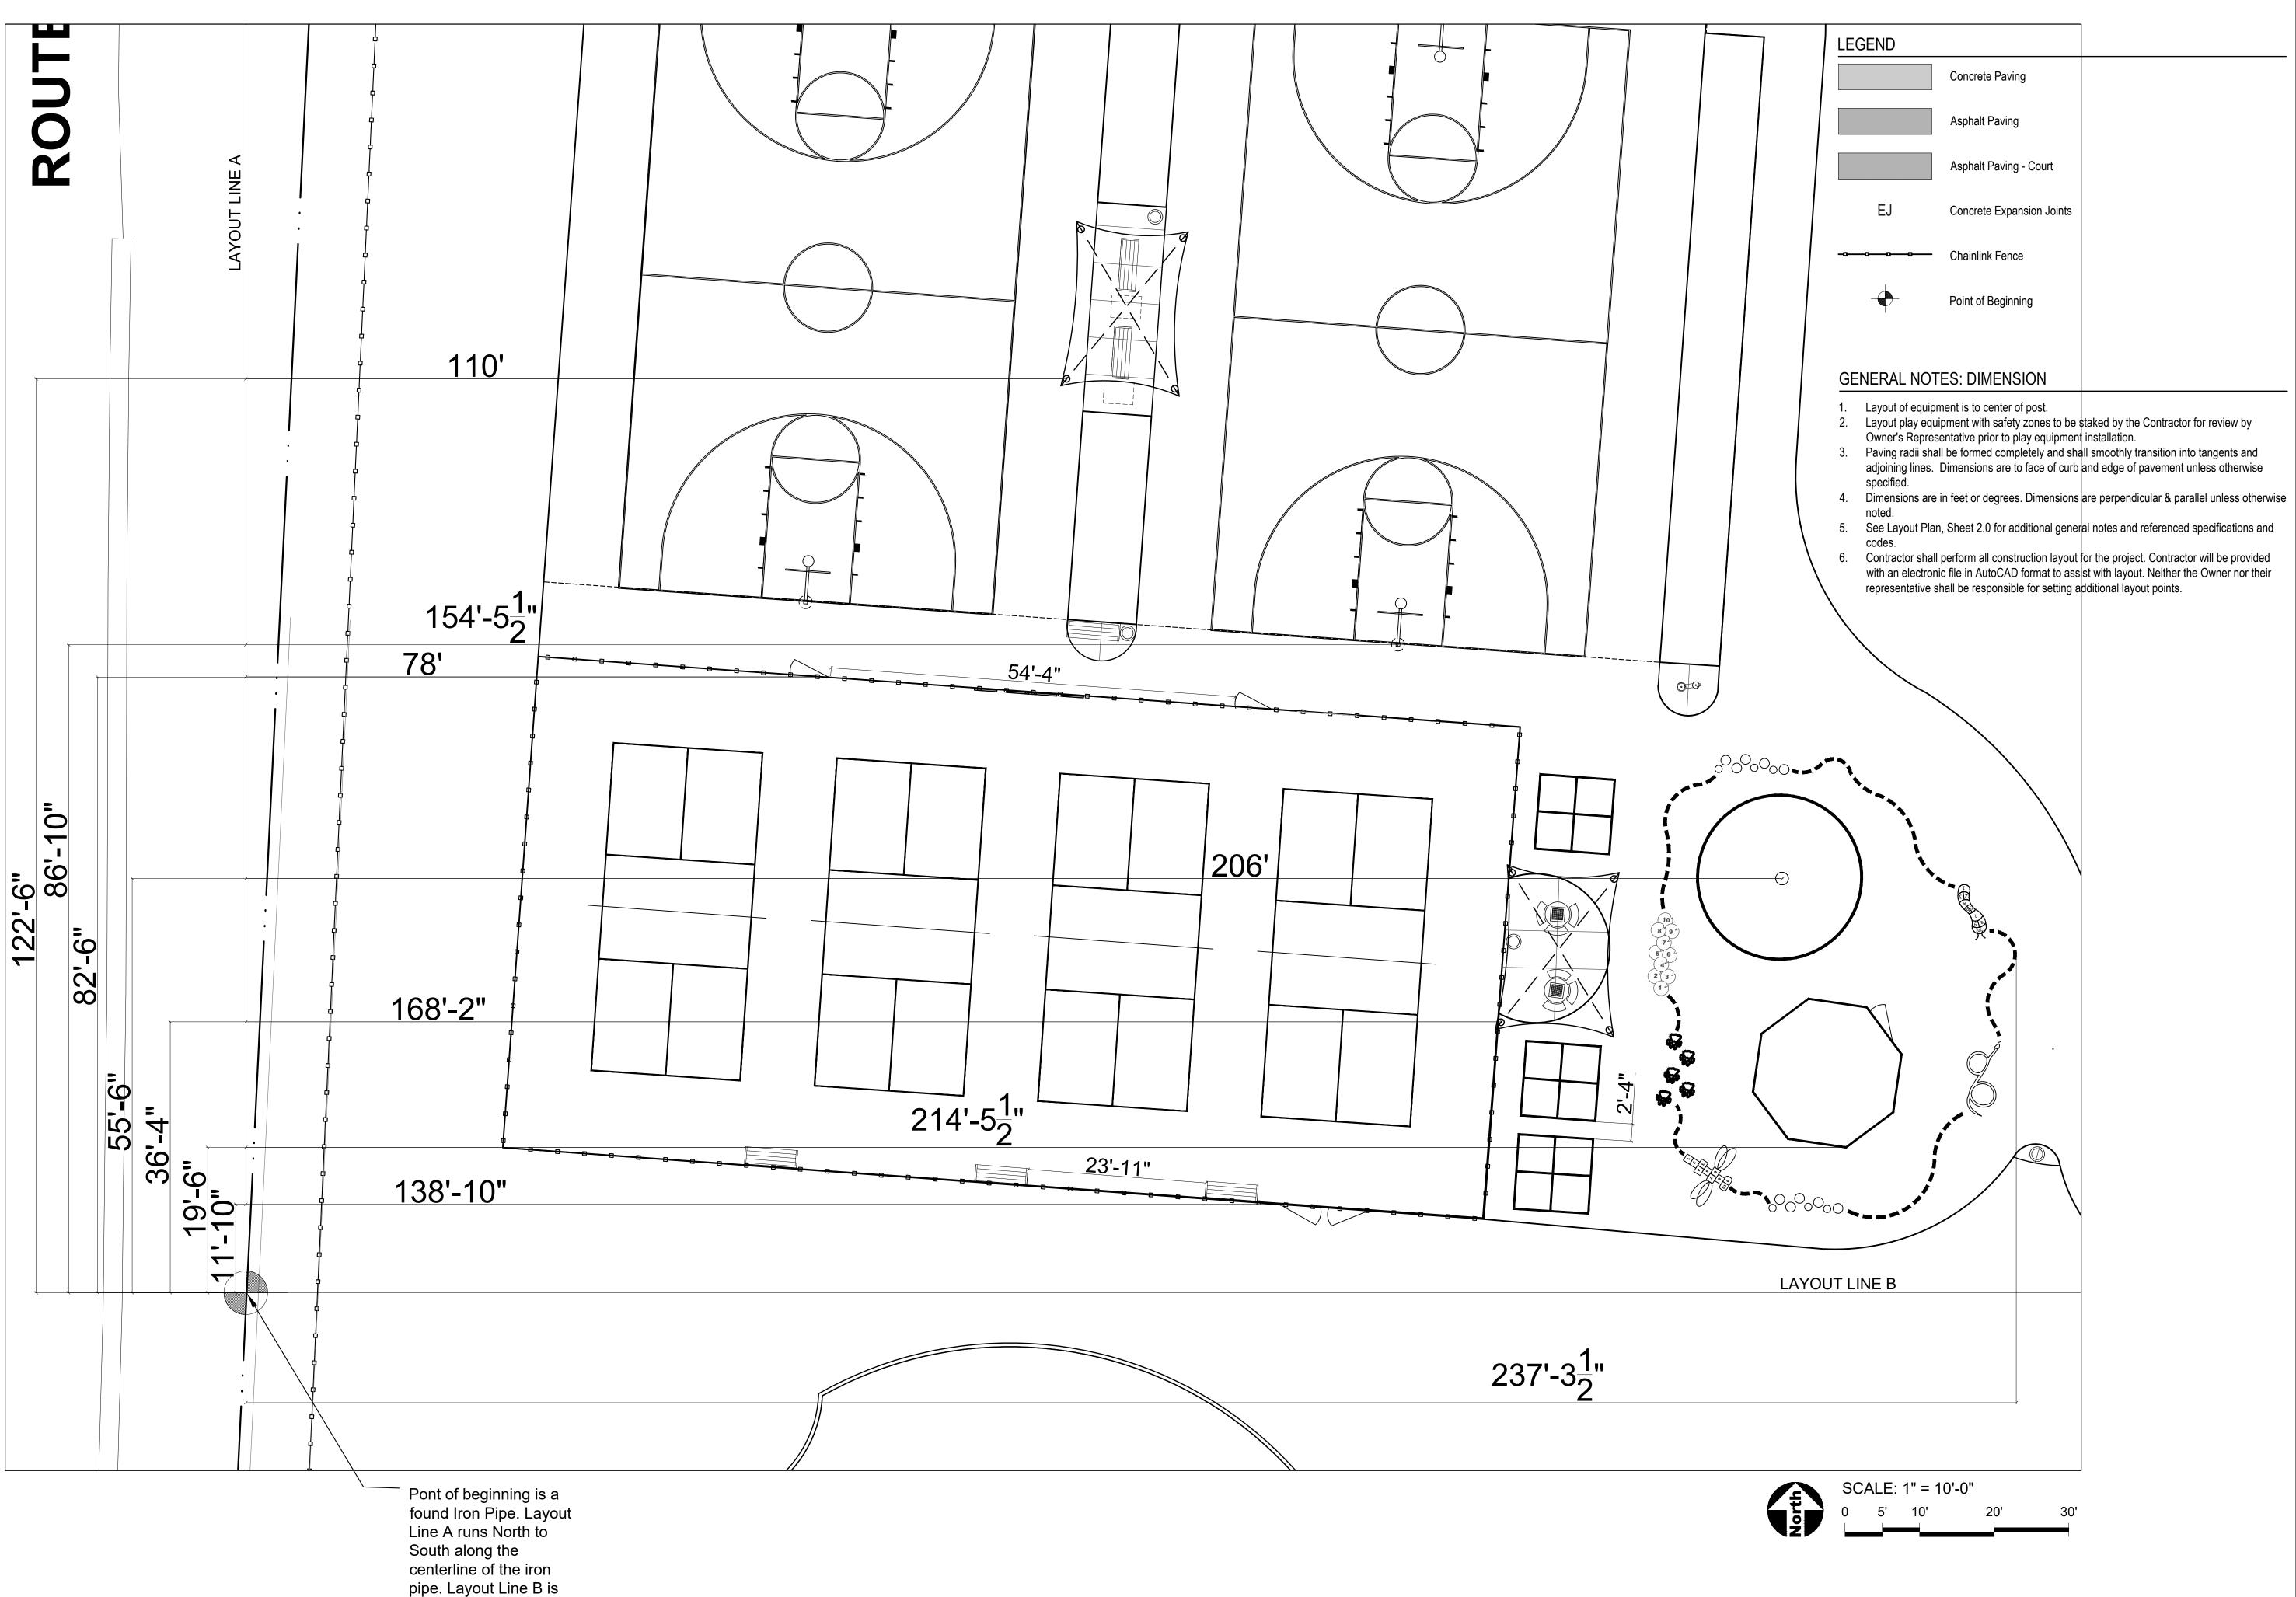

perpendicular to Layout

Line A.



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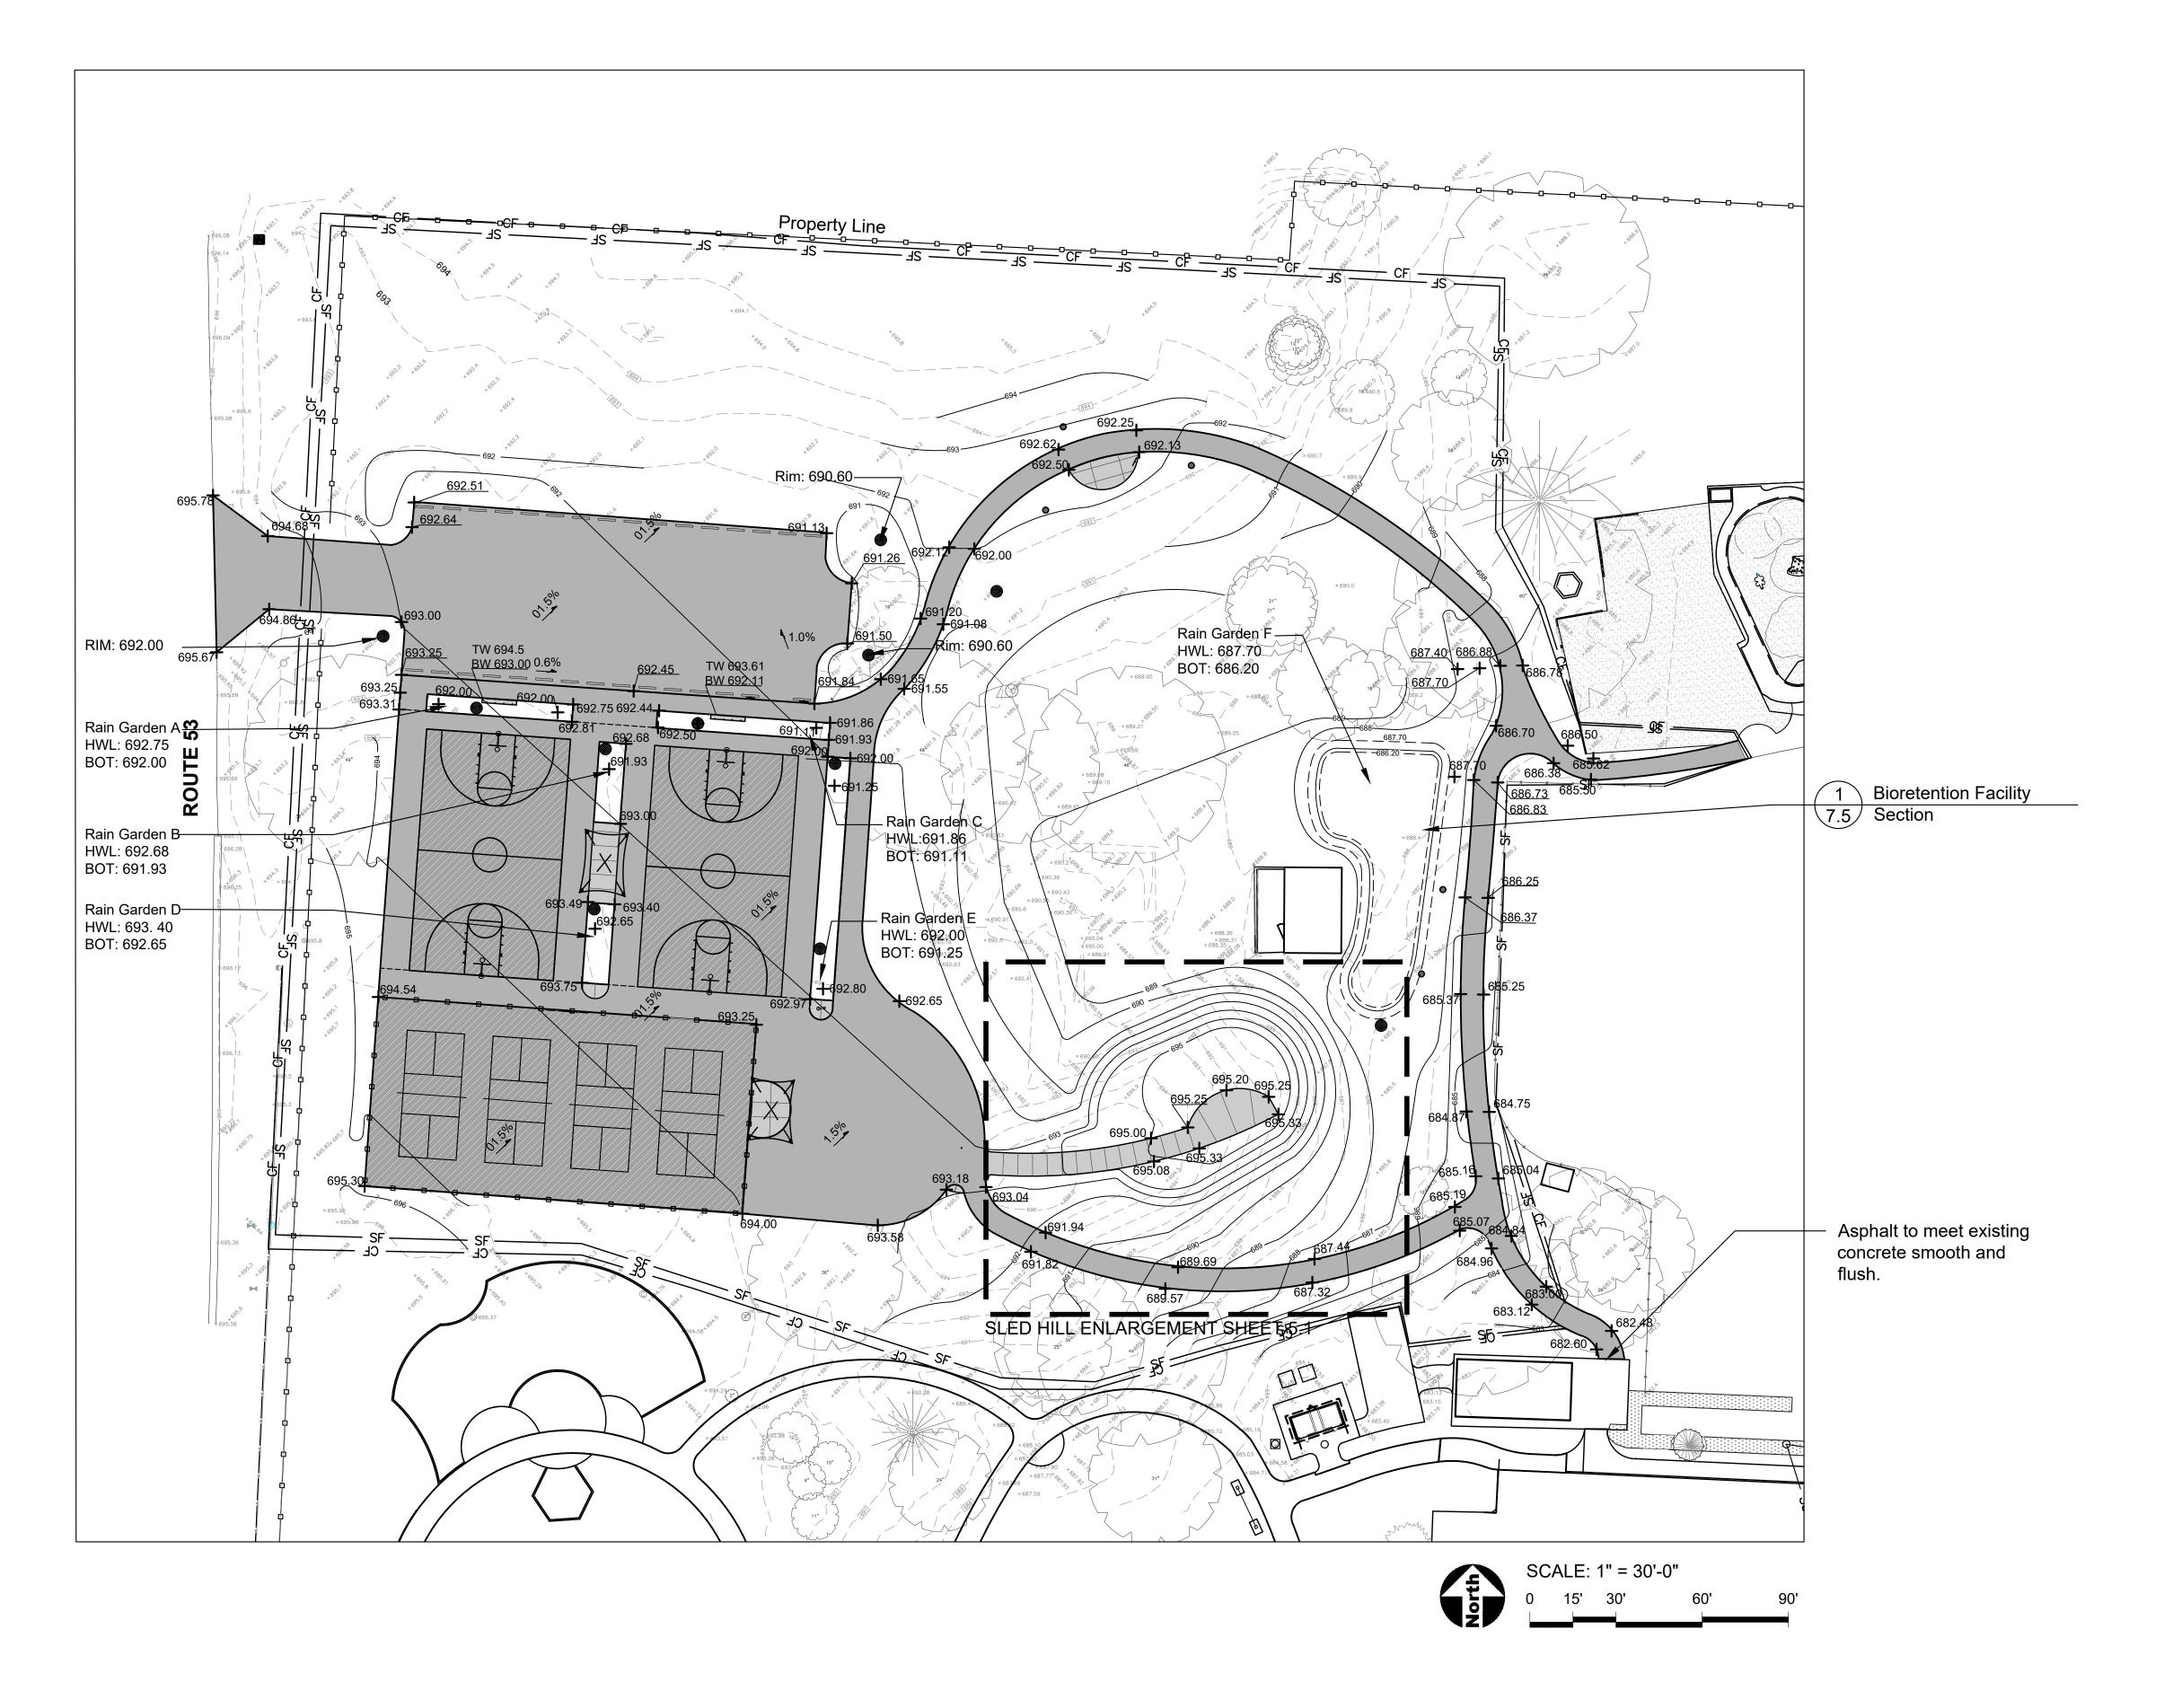
Zeitler Consulting, Inc. 1130 Randville, Unit 1B Palatine, Illinois 60074 Phone: 224-220-6030

SHEET TITLE

Dimension Plan - Site Furniture and Painted Games SHEET NUMBER 4.1

DRAW / REVISION

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GENERAL NOTES: GRADING

- Finished surfaces to be smooth and even with no abrupt or awkward changes in grade.
 Paving to meet adjacent grades flush and smooth.
- 2. Contractor shall restore all areas disturbed as a result of construction.
- 3. All walks, drives and paved areas are to follow ADA per incorporated specifications. Any deviation shall be removed and reinstalled to follow this law.
- 4. All Accessible Route paving shall not exceed 4.5% in any direction. Cross slopes shall be less than 2%. Contractor shall slope all walks and slabs to eliminate ponding. ADA Turning Radius paving shall be less than 2% in all directions.
- 5. This work shall include the excavation, stockpile, and placement of topsoil and suitable excavated material along with removal of all excess topsoil and debris off site and dispose of legally.
- 6. Follow the Illinois Procedures and Standards for Urban Soil Erosion and Sedimentation Control, IEPA Standards and Specifications for Soil Erosion and Sedimentation Control, and U.S. Soil Conservation Service Field Engineering Handbook.
- 7. Dimensions are in feet or degrees. Dimensions are perpendicular & Parallel unless
- 8. Transitions between paving types (i.e. concrete to asphalt) shall be smooth. Transitions not to exceed 1/8" vertical or horizontal difference.
- 9. Finished Surfaces to be smooth and even with no abrupt or awkward changes in grade. Paving to meet adjacent grades flush and smooth.



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INDEX OF ACRONYMS AND ABBREVIATIONS

HP - High Point

LEGEND

Existing Contour Line

Proposed Contour Line

Existing Spot Elevation

Proposed Spot Elevation

Drainage Flow Direction

— CL — Construction Limits / Construction Fence

INV - Pipe Invert Elevation

LP - Low Point

ME - Match Existing Elevation

RIM - Top of Rim Elevation

TC - Top of Curb

TP - Top of Pavement

TW - Top of Wall


SHEET TITLE

Grading Plan

SHEET NUMBER

DRAW / REVISION

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GENERAL NOTES: GRADING

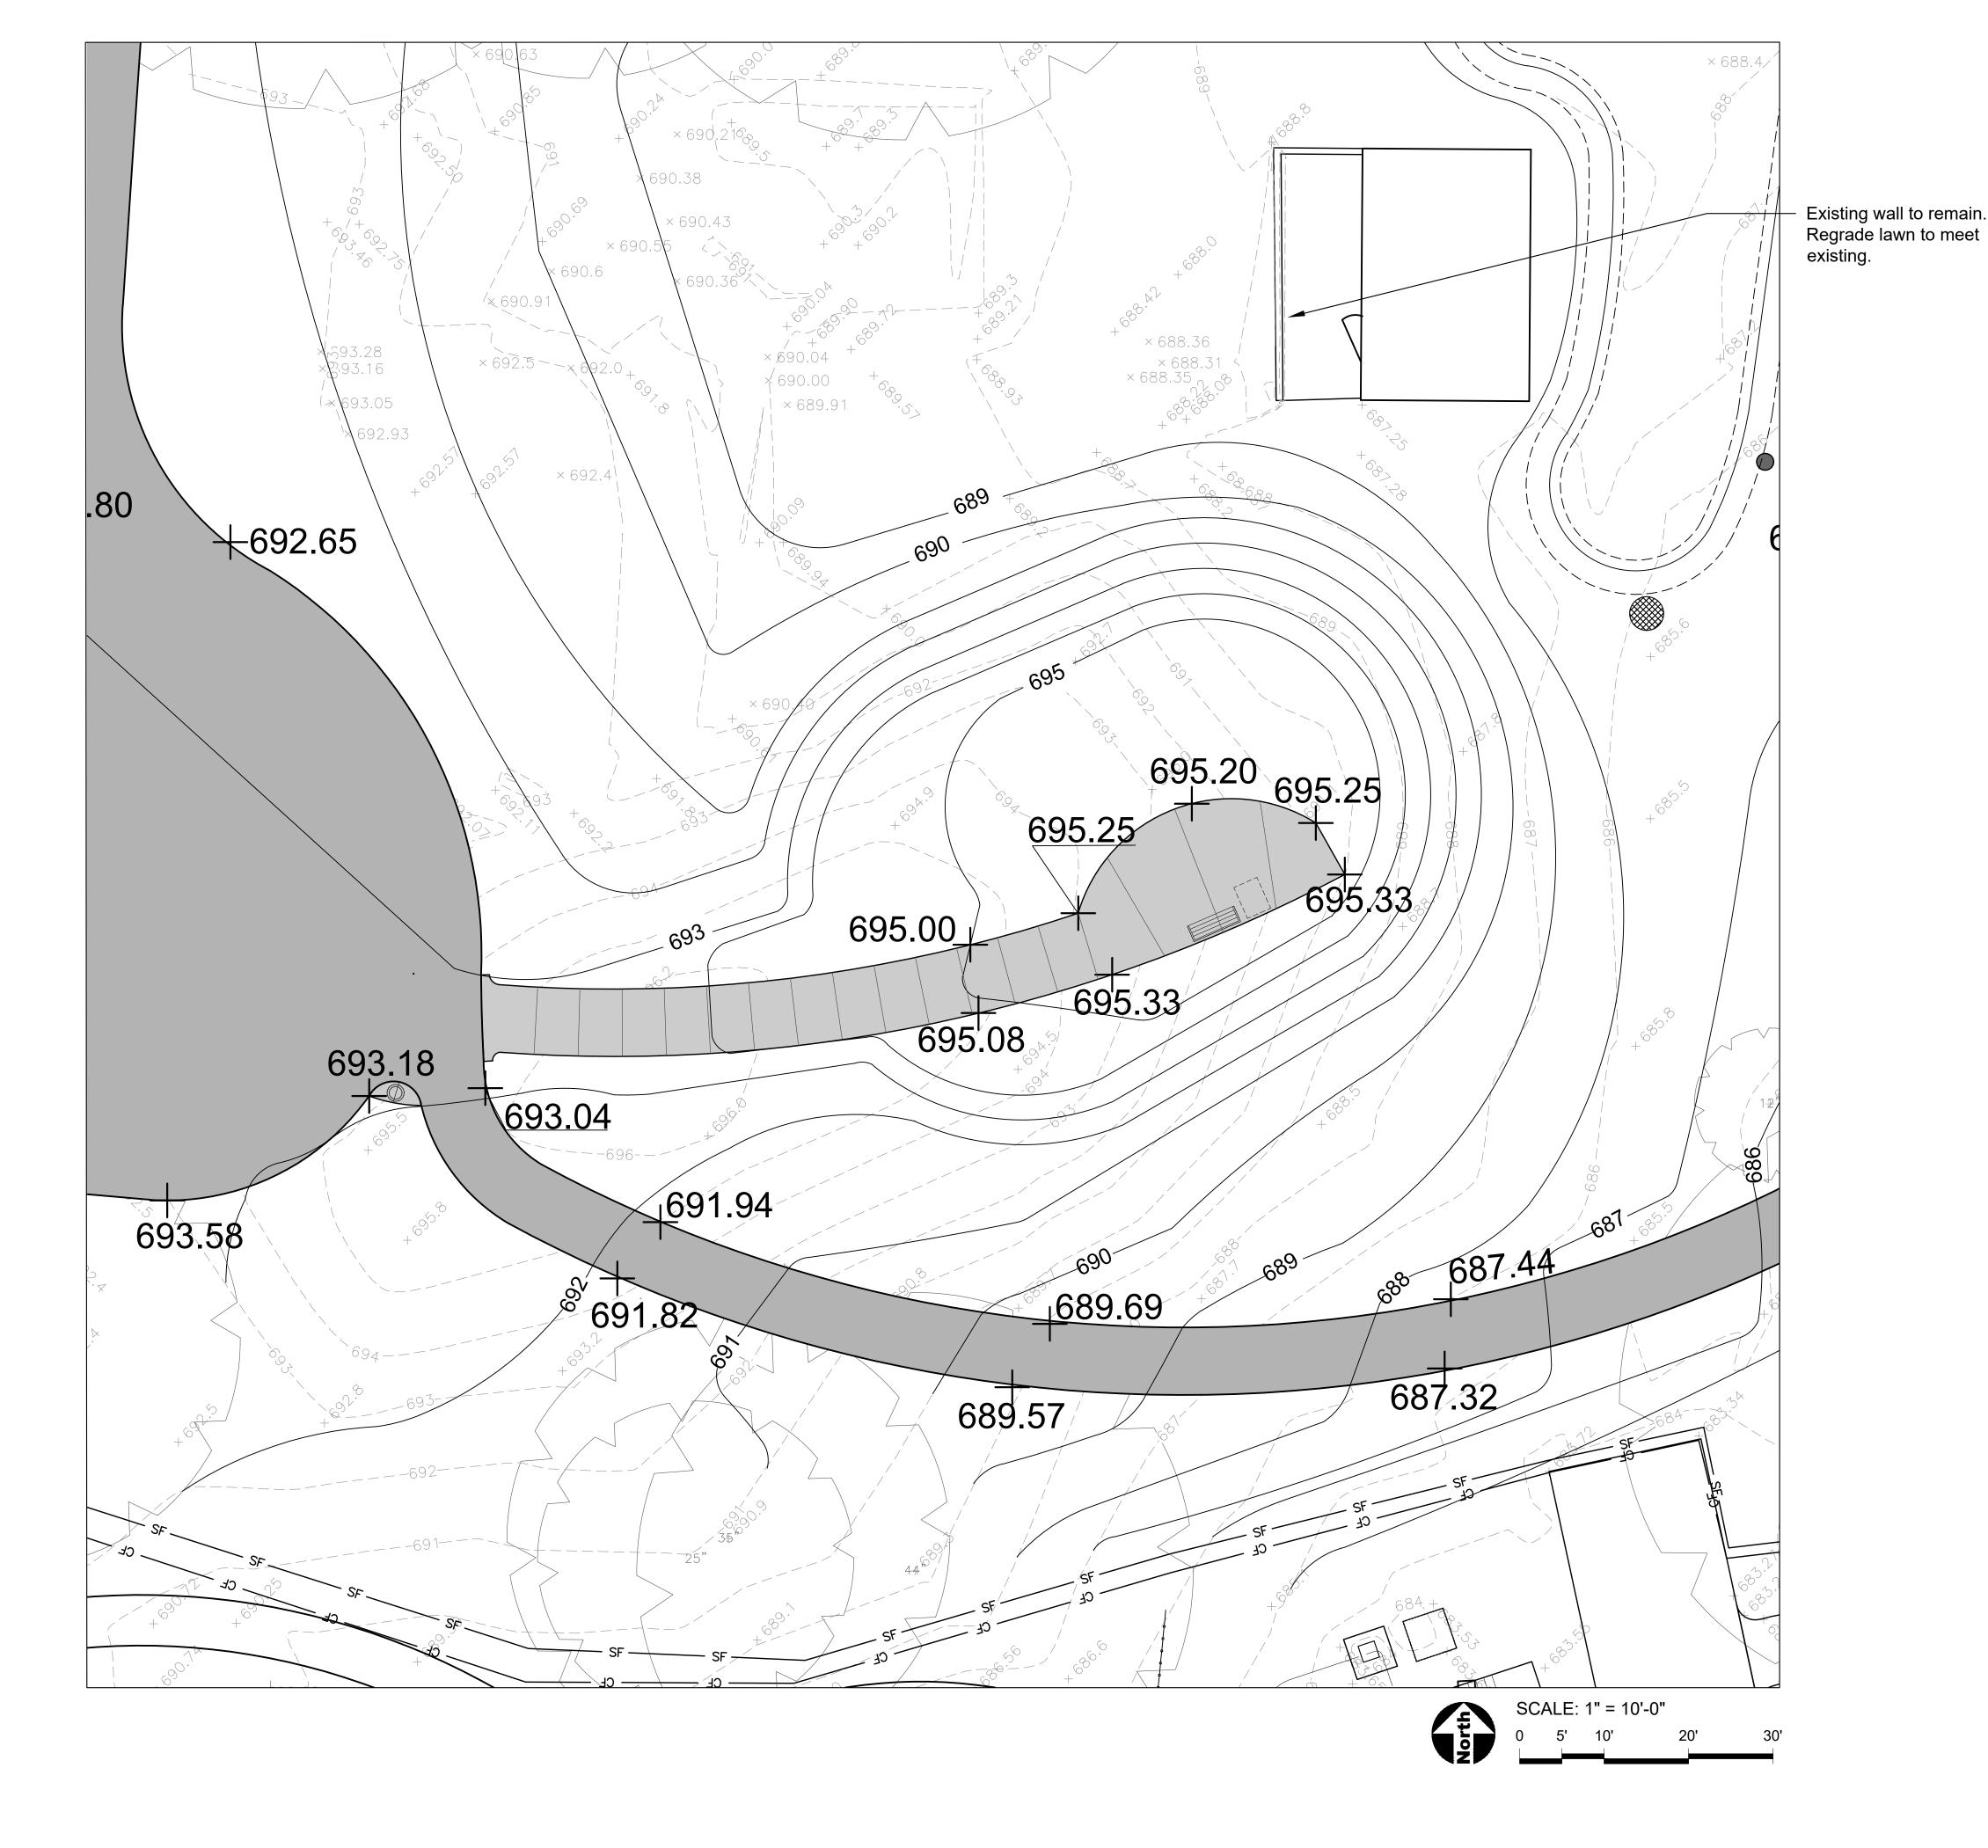1. SEE SHEET 5.0

Butterfield PARK DISTRICT

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INDEX OF ACRONYMS AND ABBREVIATIONS

HP - High Point

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TW - Top of Wall


SHEET TITLE

Grading Plan - Sled Hill Enlargement

SHEET NUMBER

DRAW / REVISION

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- 1. Water system construction shall, in all respects, be in accordance with the regulations of the environmental protection agency of the state of Illinois, and all DuPage County ordinances.
- 2. All domestic water services shall be constructed of type K copper pipe (ASTM B-88), having a minimum internal diameter of 1" (unless otherwise noted).
- 3. Horizontal separation water and sewers:
- 3.1. Watermains and services shall be located at least ten (10) feet horizontally from any existing or proposed drain, storm sewer, sanitary sewer, combined sewer or sewer service connection.
- 3.2. Watermains or services may be located closer than ten (10) feet to a sewer line when:
 3.2.1. Local conditions prevent a lateral separation of ten feet; and
- 3.2.2. The watermain or service invert is at least 18 inches above the crown of the sewer; and
- 3.2.3. The watermain or service is either in a separate trench or in the same trench on an undisturbed earth shelf located to one side of the sewer.
- 4. Vertical separation watermains or service and sewers:
- 4.1. A watermain or service shall be separated from a sewer so that its invert is a minimum of 18 inches above the crown of the drain or sewer whenever watermains or services cross storm sewers, sanitary sewers or sewer service connections. The vertical separation shall be maintained for that portion of the watermain or service located within ten (10) feet horizontally of any sewer or drain crossed. A length of watermain or service pipe shall be centered over the sewer to be crossed with joints equidistant from the sewer or drain.
- The watermain or service or sewer shall be constructed of slip-on or mechanical joint cast or pvc pipe equivalent to watermain standards of construction when:
- cast or pvc pipe equivalent to watermain standards of construction when:

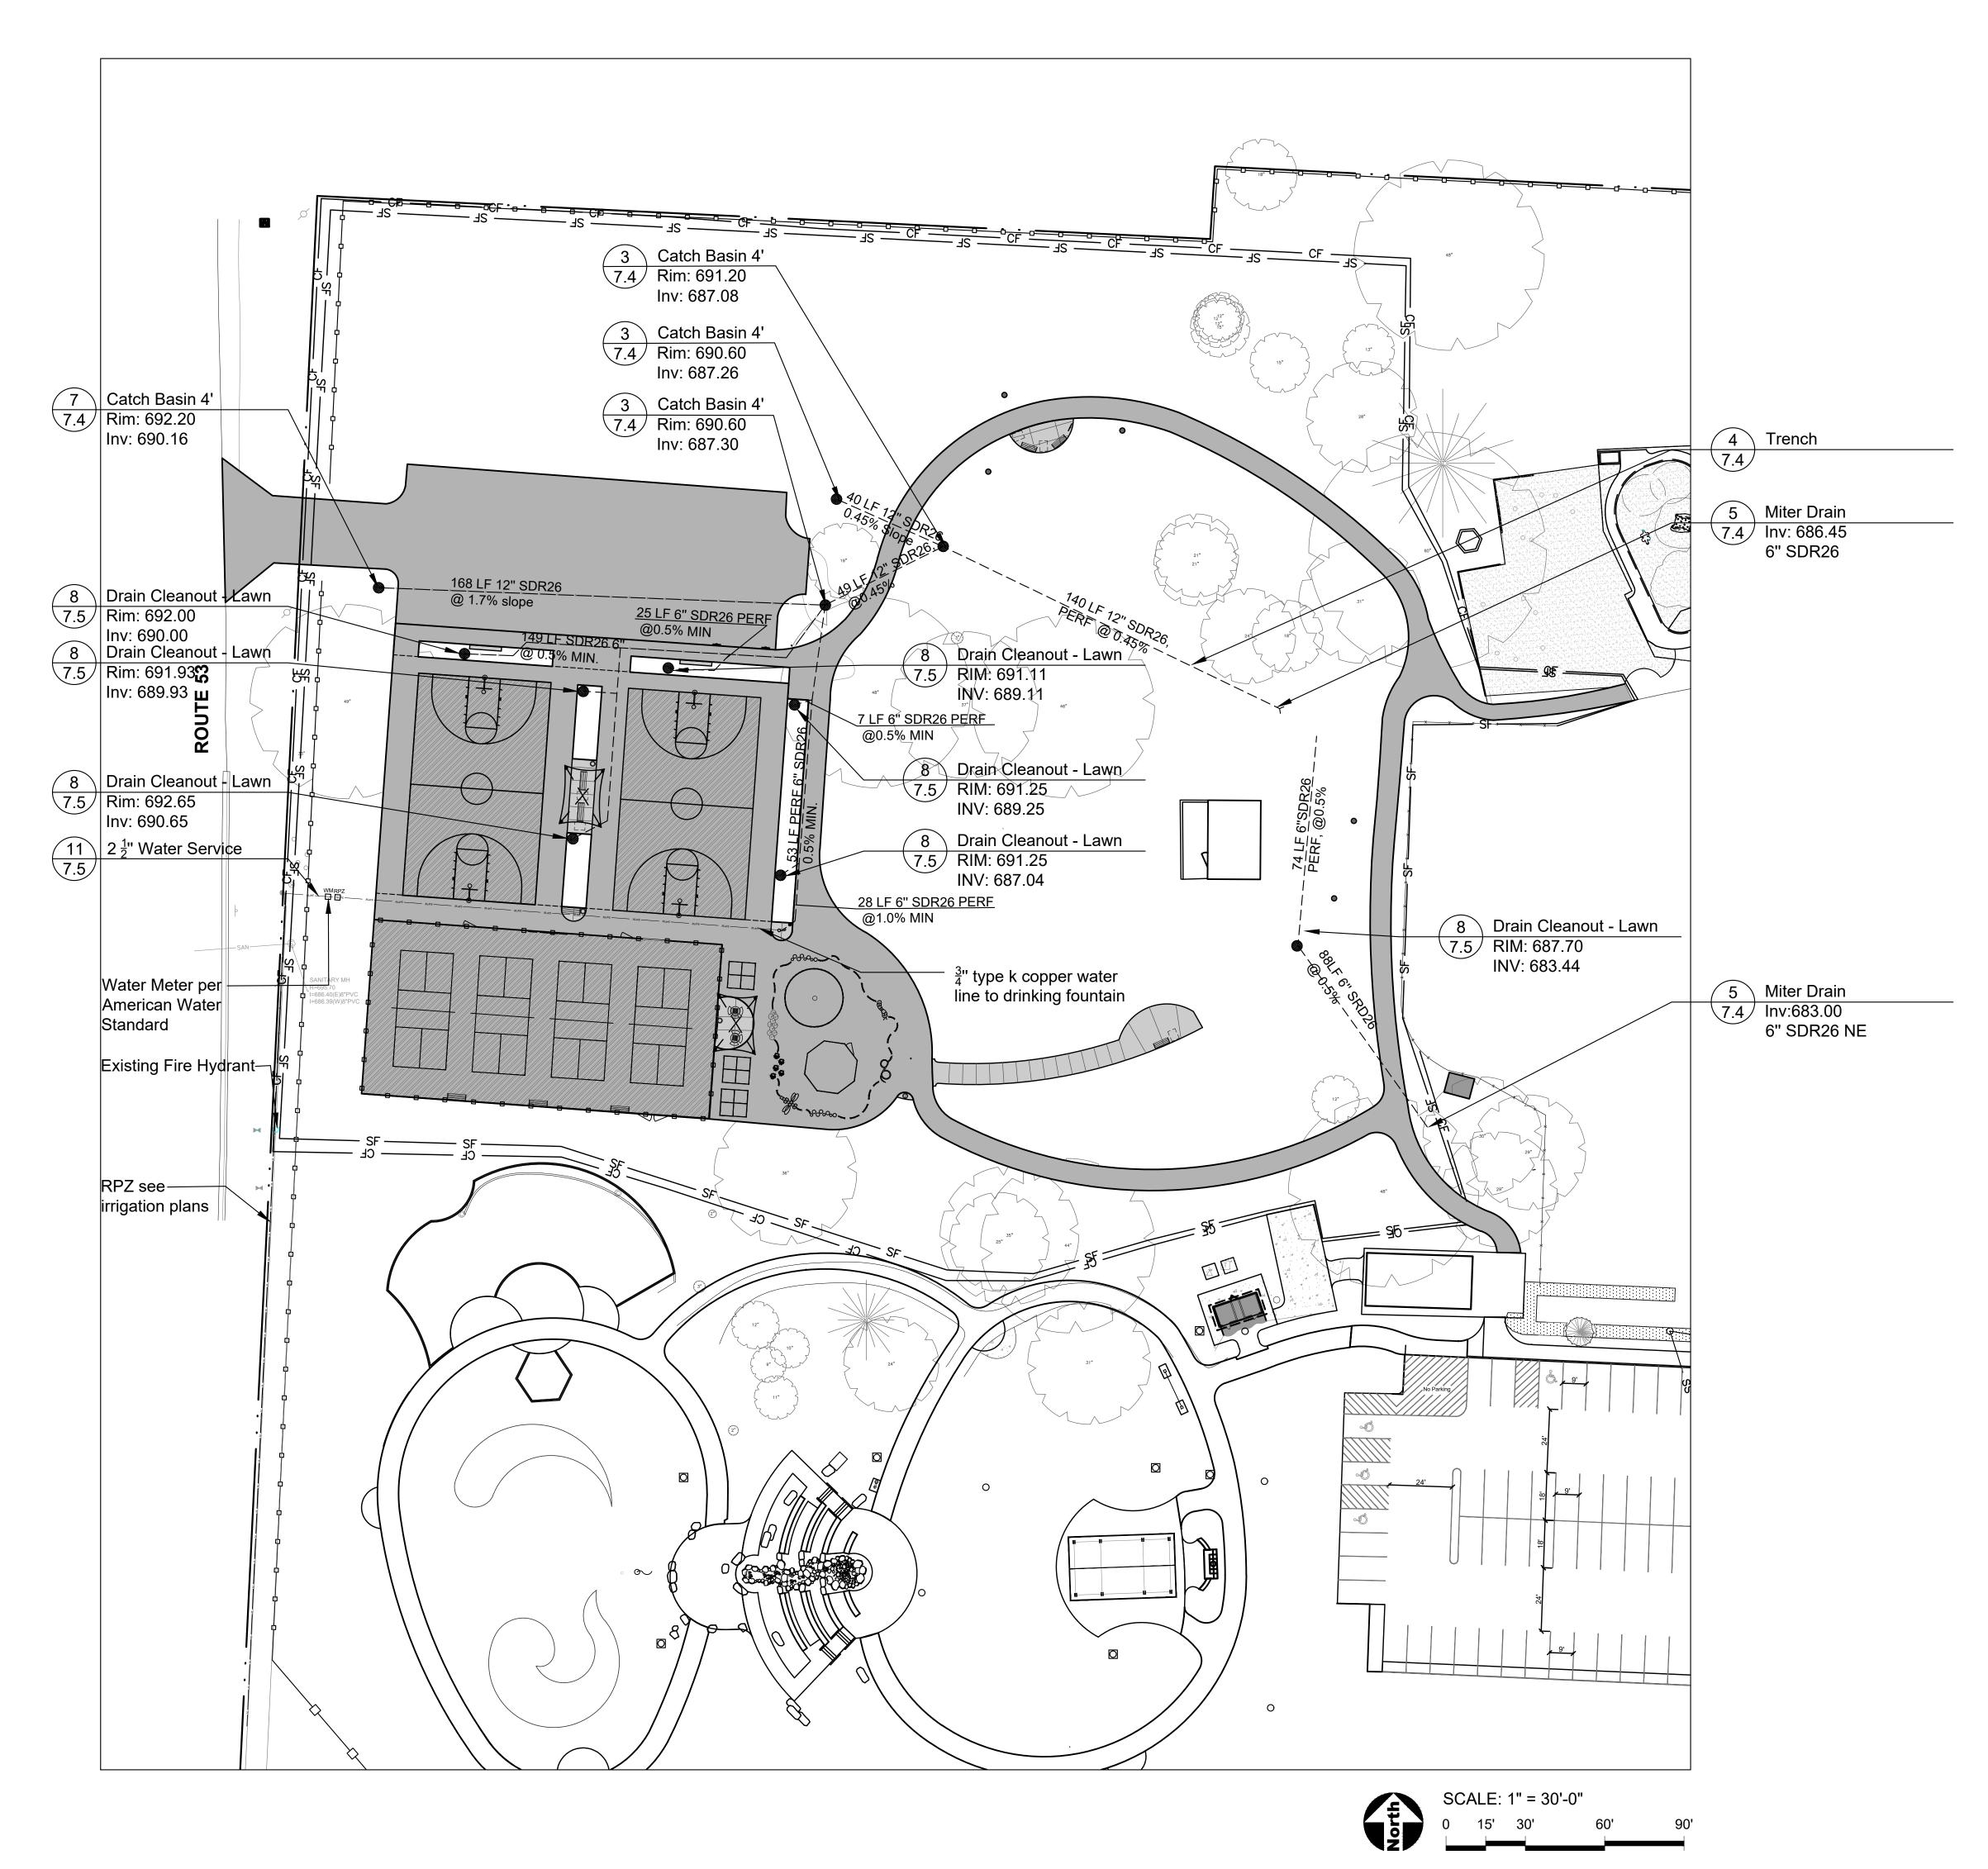 2.1. It is impossible to obtain the proper vertical separation as described in (1) above.
- 4.2.2. The watermain or service passes under a sewer or drain.
- 3. A vertical separation of 18 inches between the invert of the sewer or drain and the crown of the watermain or service shall be maintained where a watermain or service crosses under a sewer. support the sewer or drain lines to prevent settling and breaking the watermain or service, as shown on the plans or approved by the
- 4.4. Construction shall extend on each side of the crossing until the perpendicular distance from the watermain to the sewer or drain line is at least ten feet.
- Installed watermain or service shall be pressure-tested in accordance with DuPage County Department of Public Works prior to final acceptance.
- 6. Installed watermain or service shall be disinfected and tested according to the requirements of the "Standards for Disinfecting Watermains", AWWA C-601, and as required by county code. All disinfection, as required, shall be performed by an independent firm exhibiting experience in the methods and techniques of this operation.
- 7. All new plumbing fixtures must bear the water sense label. DO NOT REMOVE THE WATERSENSE LABEL PRIOR TO PASSING THE FINAL INSPECTION AND HAVE FIXTURE CUT SHEETS ONSITE FOR FINAL INSPECTION.
- 8. A stack test is required on all waste and vent piping at the time of rough and underground inspections.
- 9. 75 psi air test or water on required on all water piping at time of rough inspection.




PROJECT

Glenbriar OSLAD Phase III Development

21W730 Butterfield Rd Lombard, Illinois 60148

PROJECT TEAM

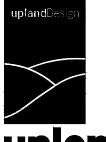

uplandDesign Itd

Landscape Architecture & Park Planning Chicago, Illinois 312-350-4088 Plainfield, Illinois 815-254-0091 uplandDesign.com

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Engineering Resource Associates 3S701 West Avenue Suite 150 Warrenville, IL 60555 Phone: 630-393-3060

SURVEYOR

Zeitler Consulting, Inc. 1130 Randville, Unit 1B Palatine, Illinois 60074 Phone: 224-220-6030

SHEET TITLE

Utility Plan

SHEET NUMBER

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DRAW / REVISION

LD/JF Issue for Permit 17JUL2023
Project Number 999-1117

5.2

 LEGEND

 — 1''W — Water Line


 — SAN — Sanitary Sewer Line


 — Storm Sewer Line

 ☐ Drain Structure

 — Outlet Structure

 — Perforated Pipe

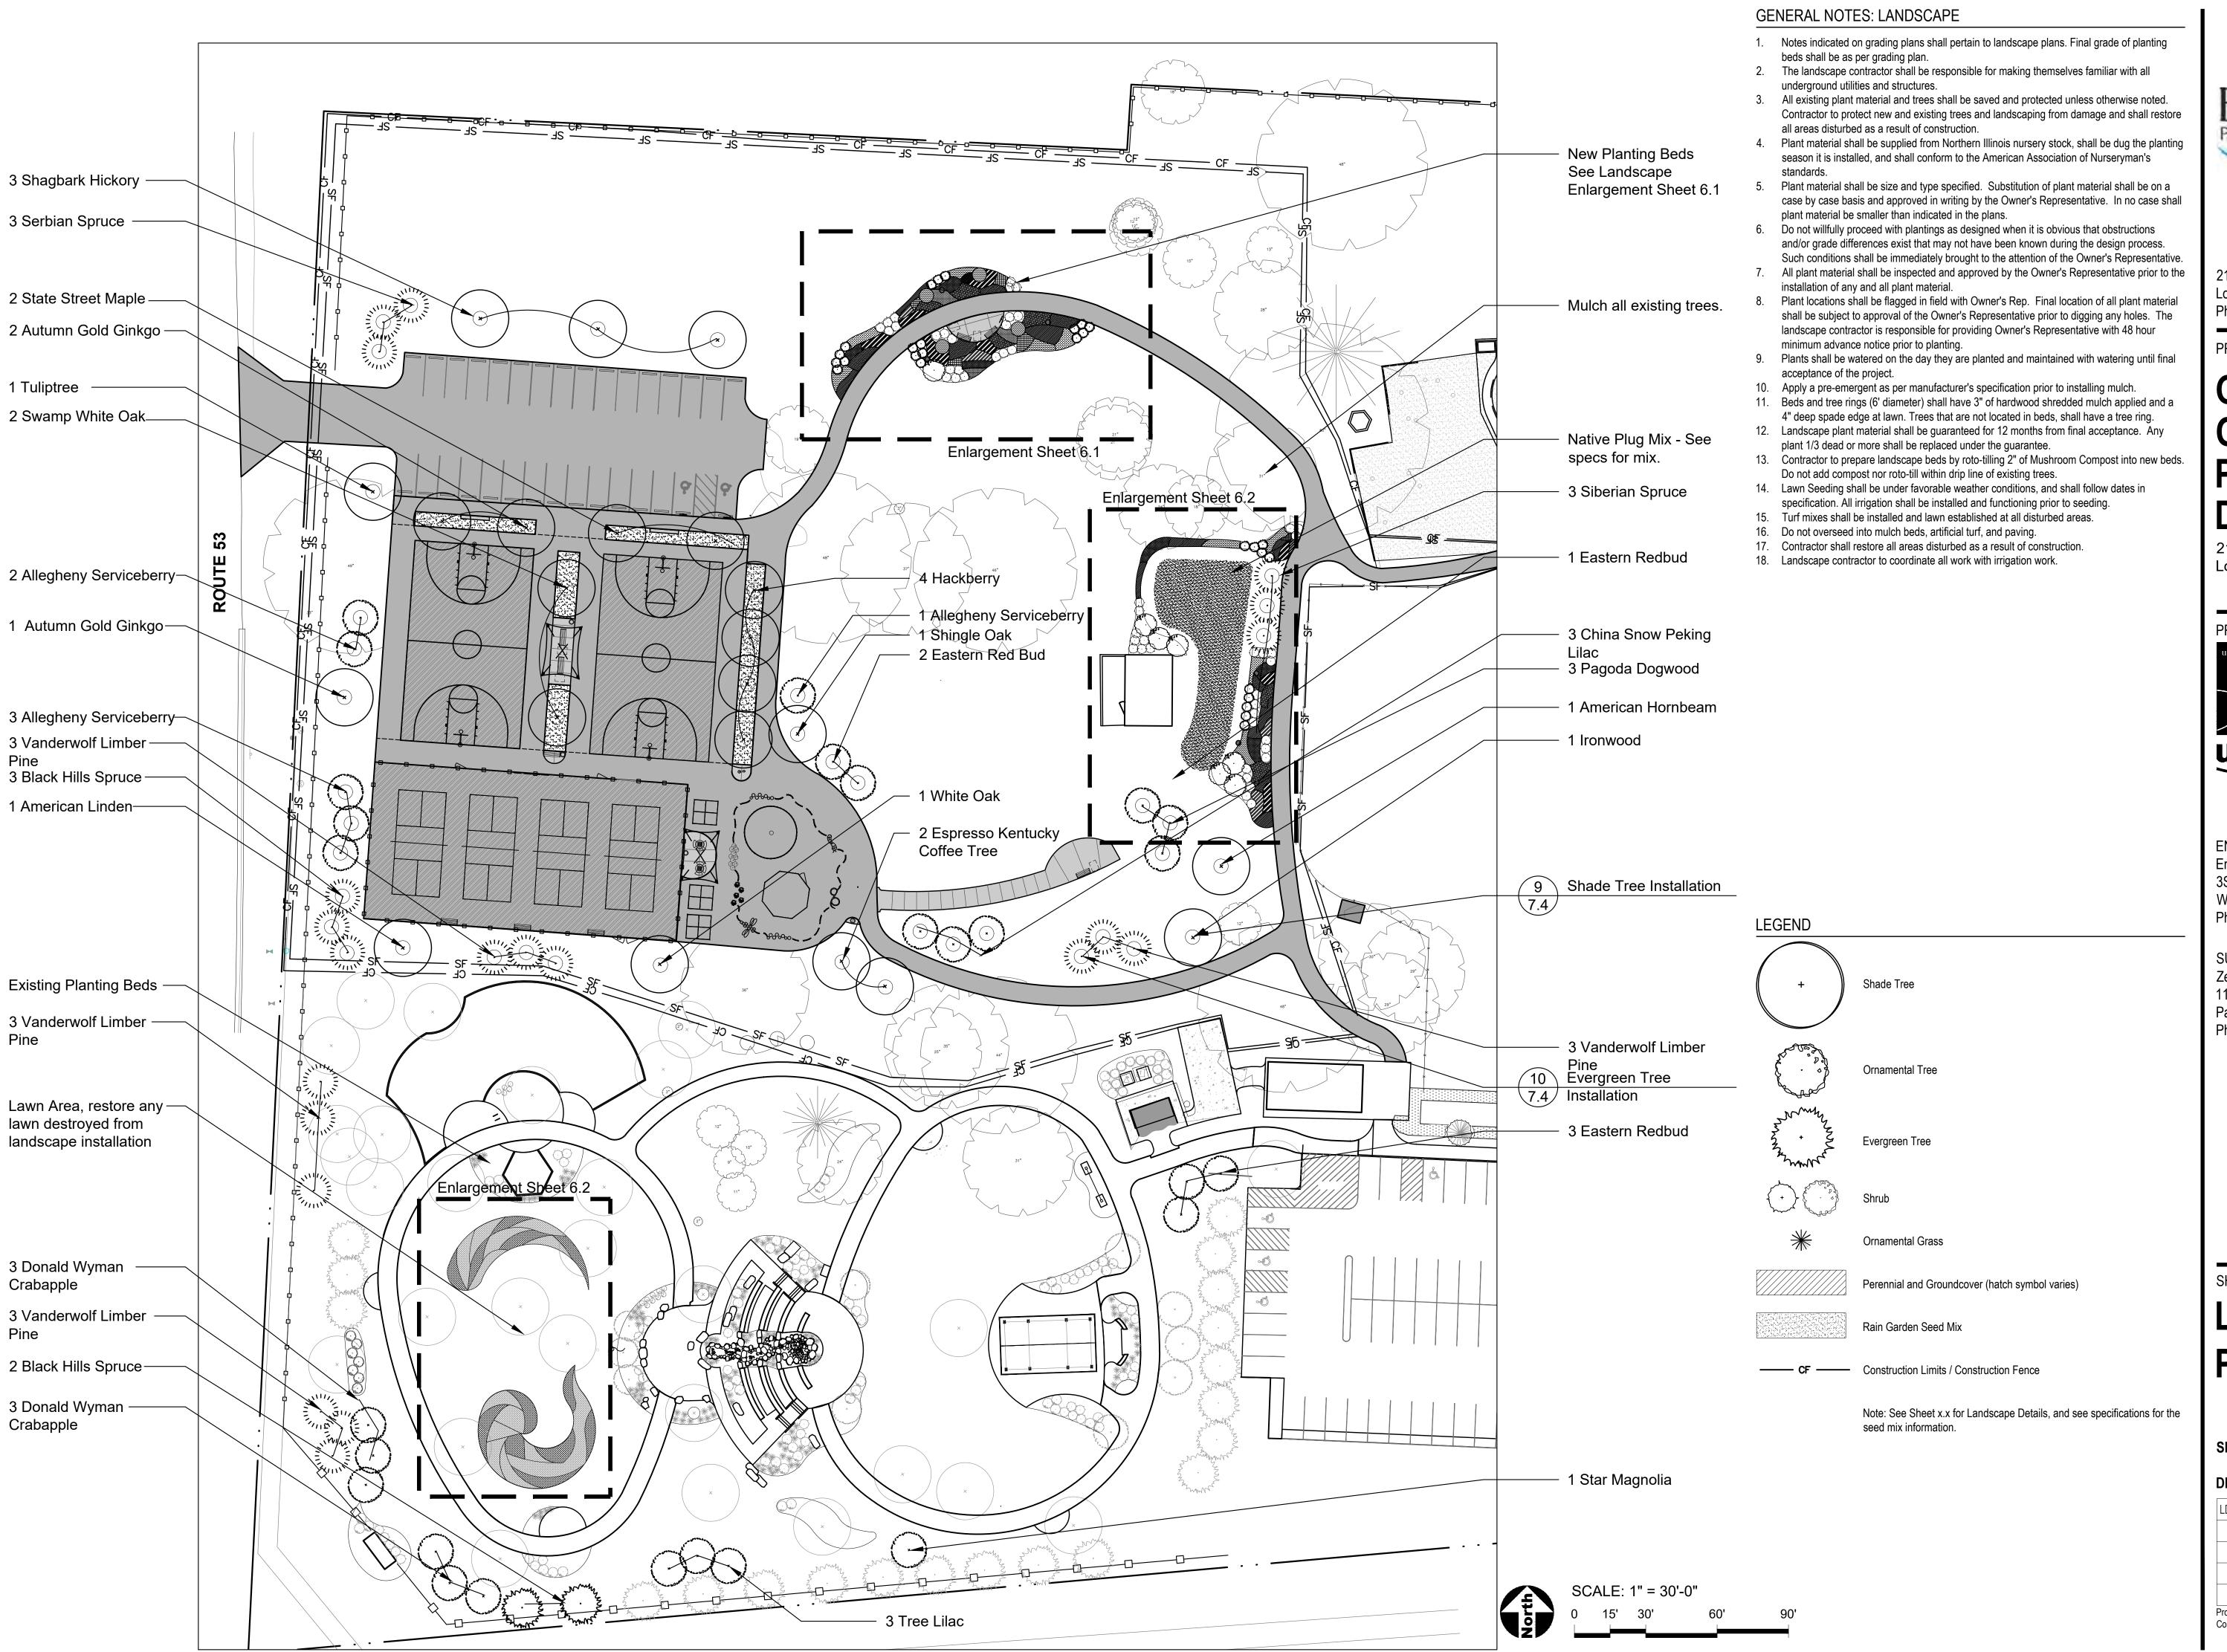

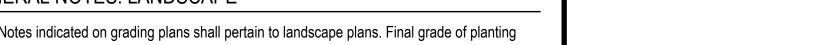



PROJECT

Glenbriar **OSLAD** Phase III **Development**

21W730 Butterfield Rd Lombard, Illinois 60148

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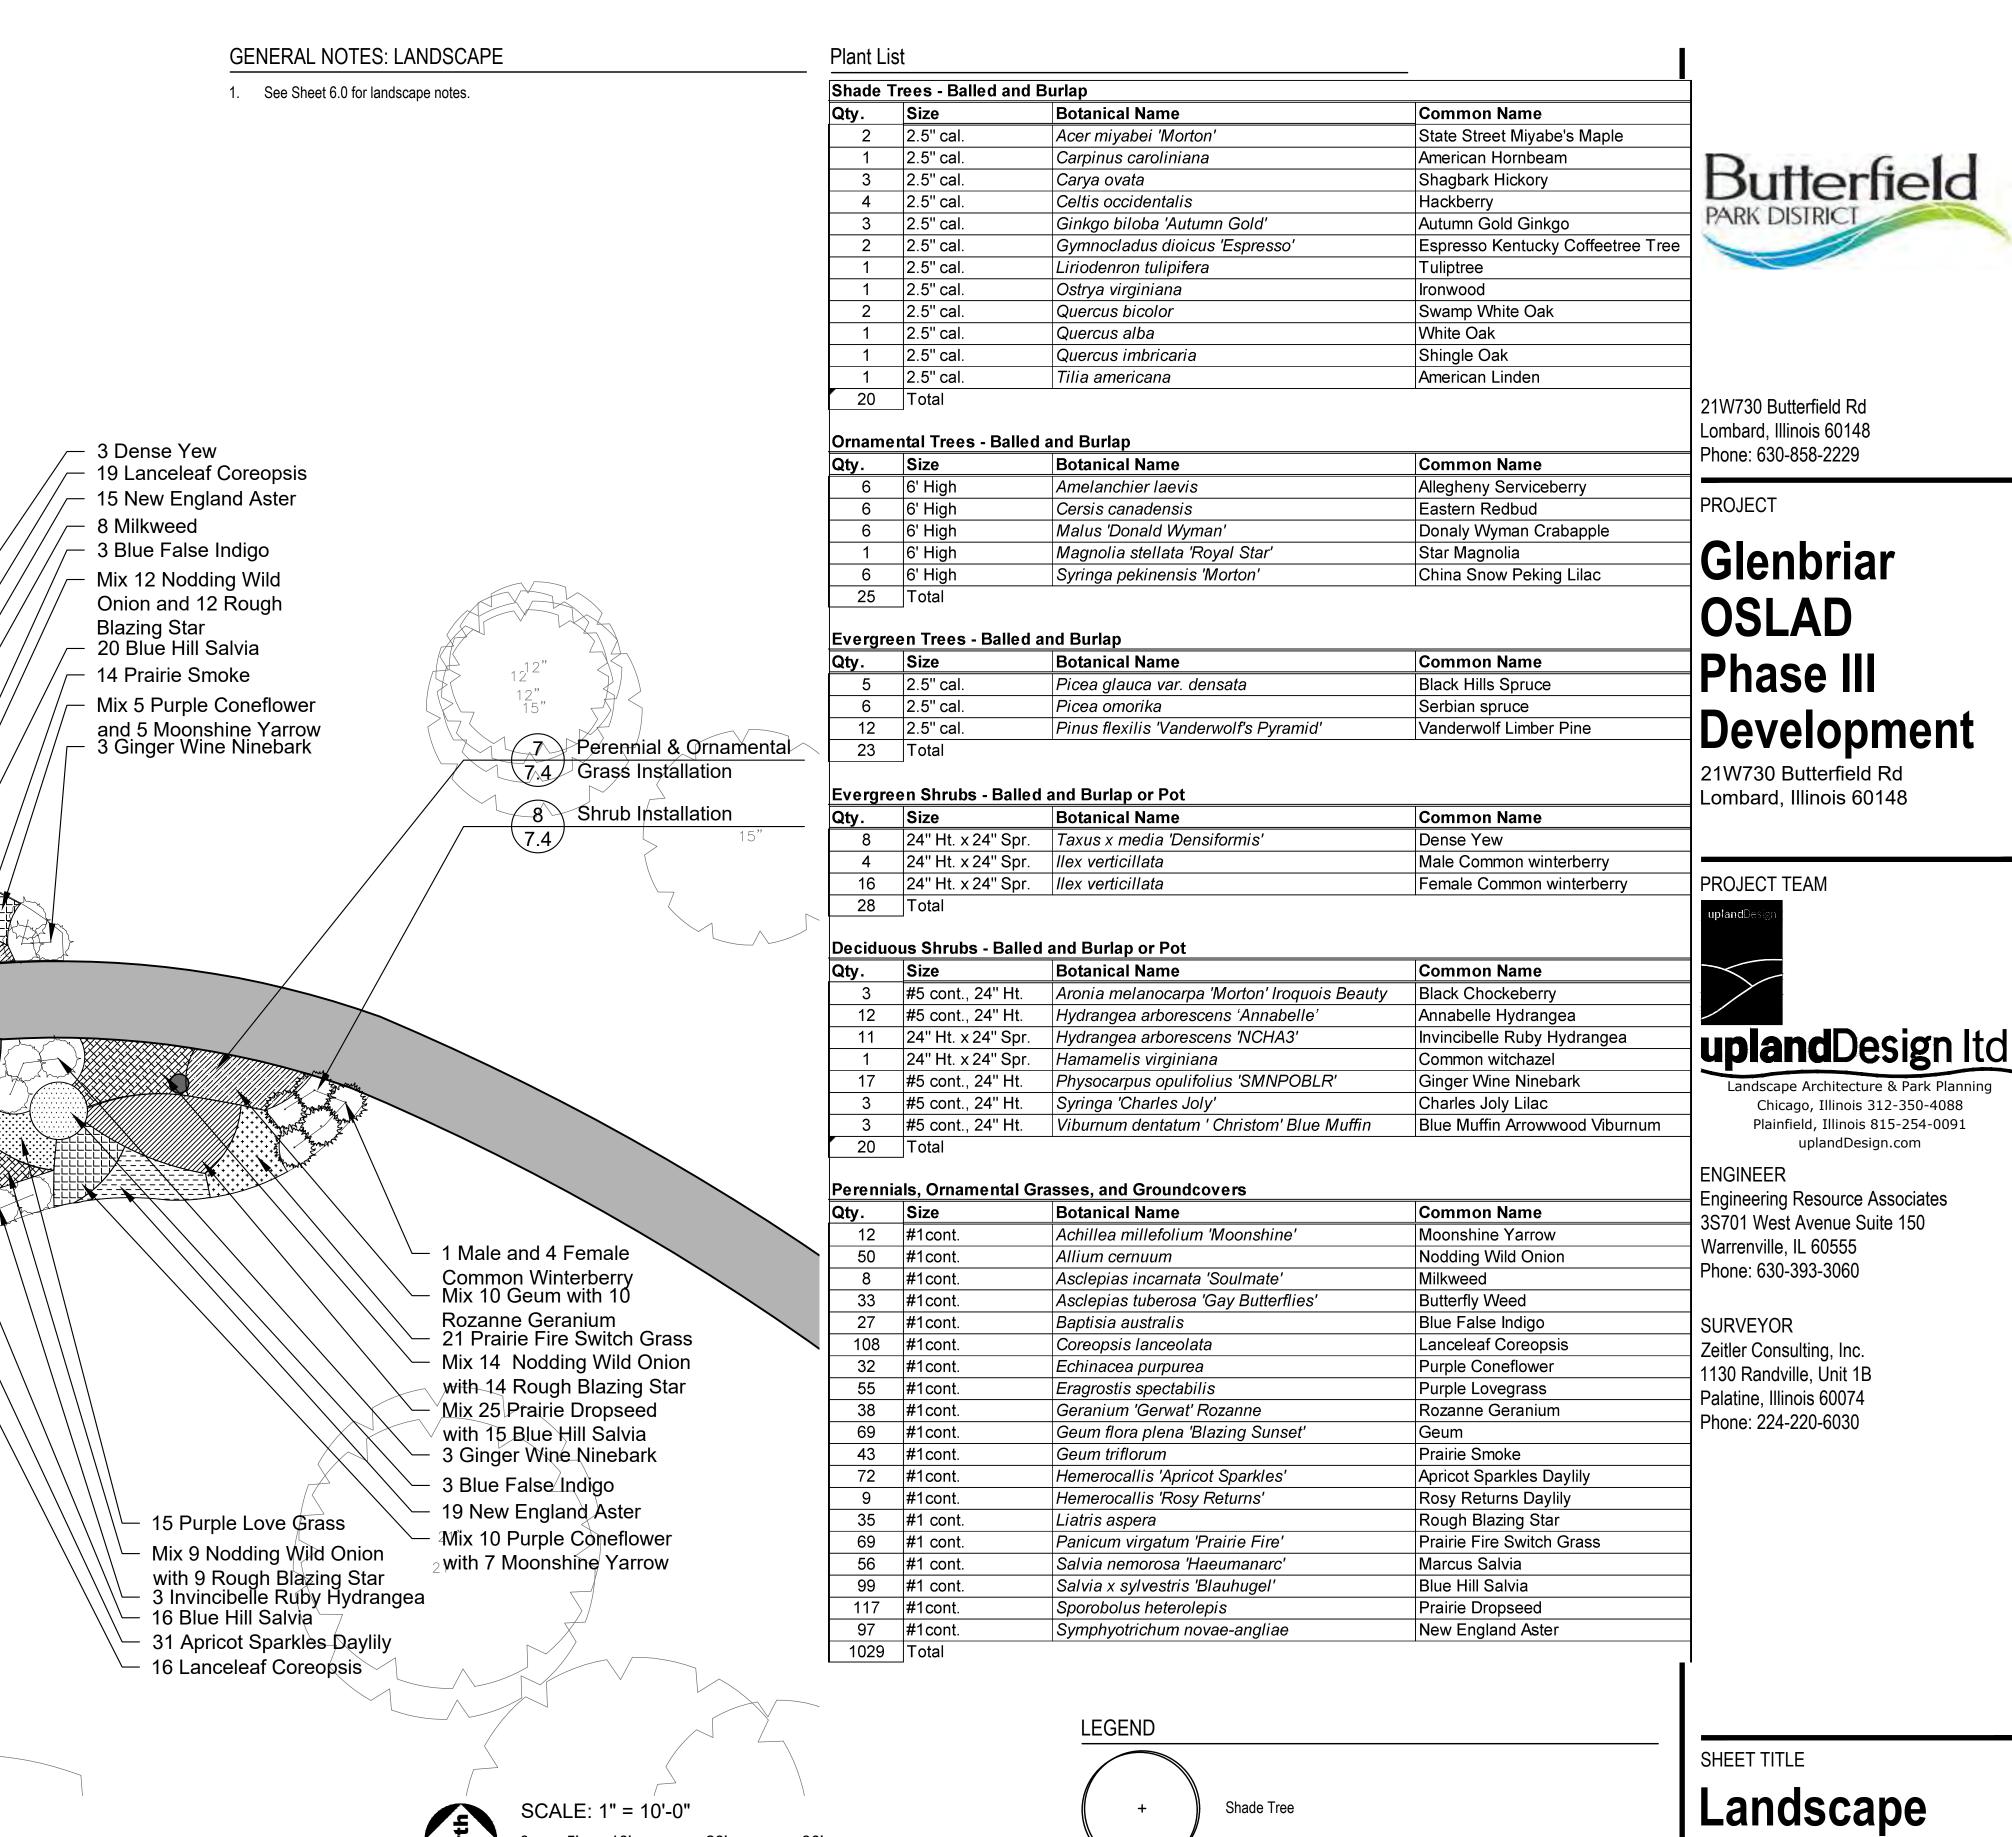
SHEET TITLE

Landscape Plan

SHEET NUMBER

| DRAW / | REVISION |
|--------|------------------|
| LD/JF | Issue for Permit |
| | |

| .D/JF | Issue for Permit | 17JUL2023 |
|-------|---------------------------------------|-----------|
| | | |
| | | |
| | | |
| | | |
| | ber 999-1117 23 Upland Design Ltd. | |



Ornamental Tree

Evergreen Tree

Ornamental Grass

Perennial and Groundcover (hatch symbol varies)

14 Prairie Dropseed-

22 Purple Love Grass—

3 Blue False Indigo-

5 Purple Coneflower-

15 Marcus Salvia -

5 Invincibelle Ruby -

Hydrangea

Grass

15 Nodding Wild Onion-

9 Rosy Returns Daylily-

22 Prairie Fire Switch-

12 Lanceleaf Coreopsis-

Mix 10 Geum and 10—

Rozanne Geranium

1 Male an 4 Female

14 Prairie Dropseed

Common Winterberry

18 New England Aster

Male and 4 Female-

Common Winterberry

1 Common Witchazel

3 Ginger Wine Ninebark

[′] 28 Blue Hill Salvia−

3 Blue False Indigo

7 Purple Coneflower

5 Annabelle Hydrangea

11 New England Aster


29 Prairie Smoke


18 Marcus Salvia

Enlargement -Bird Habitat 1

SHEET NUMBER

DRAW / REVISION

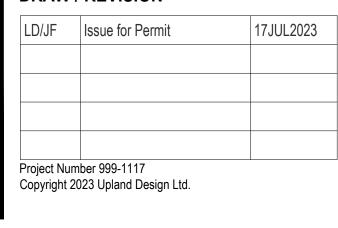

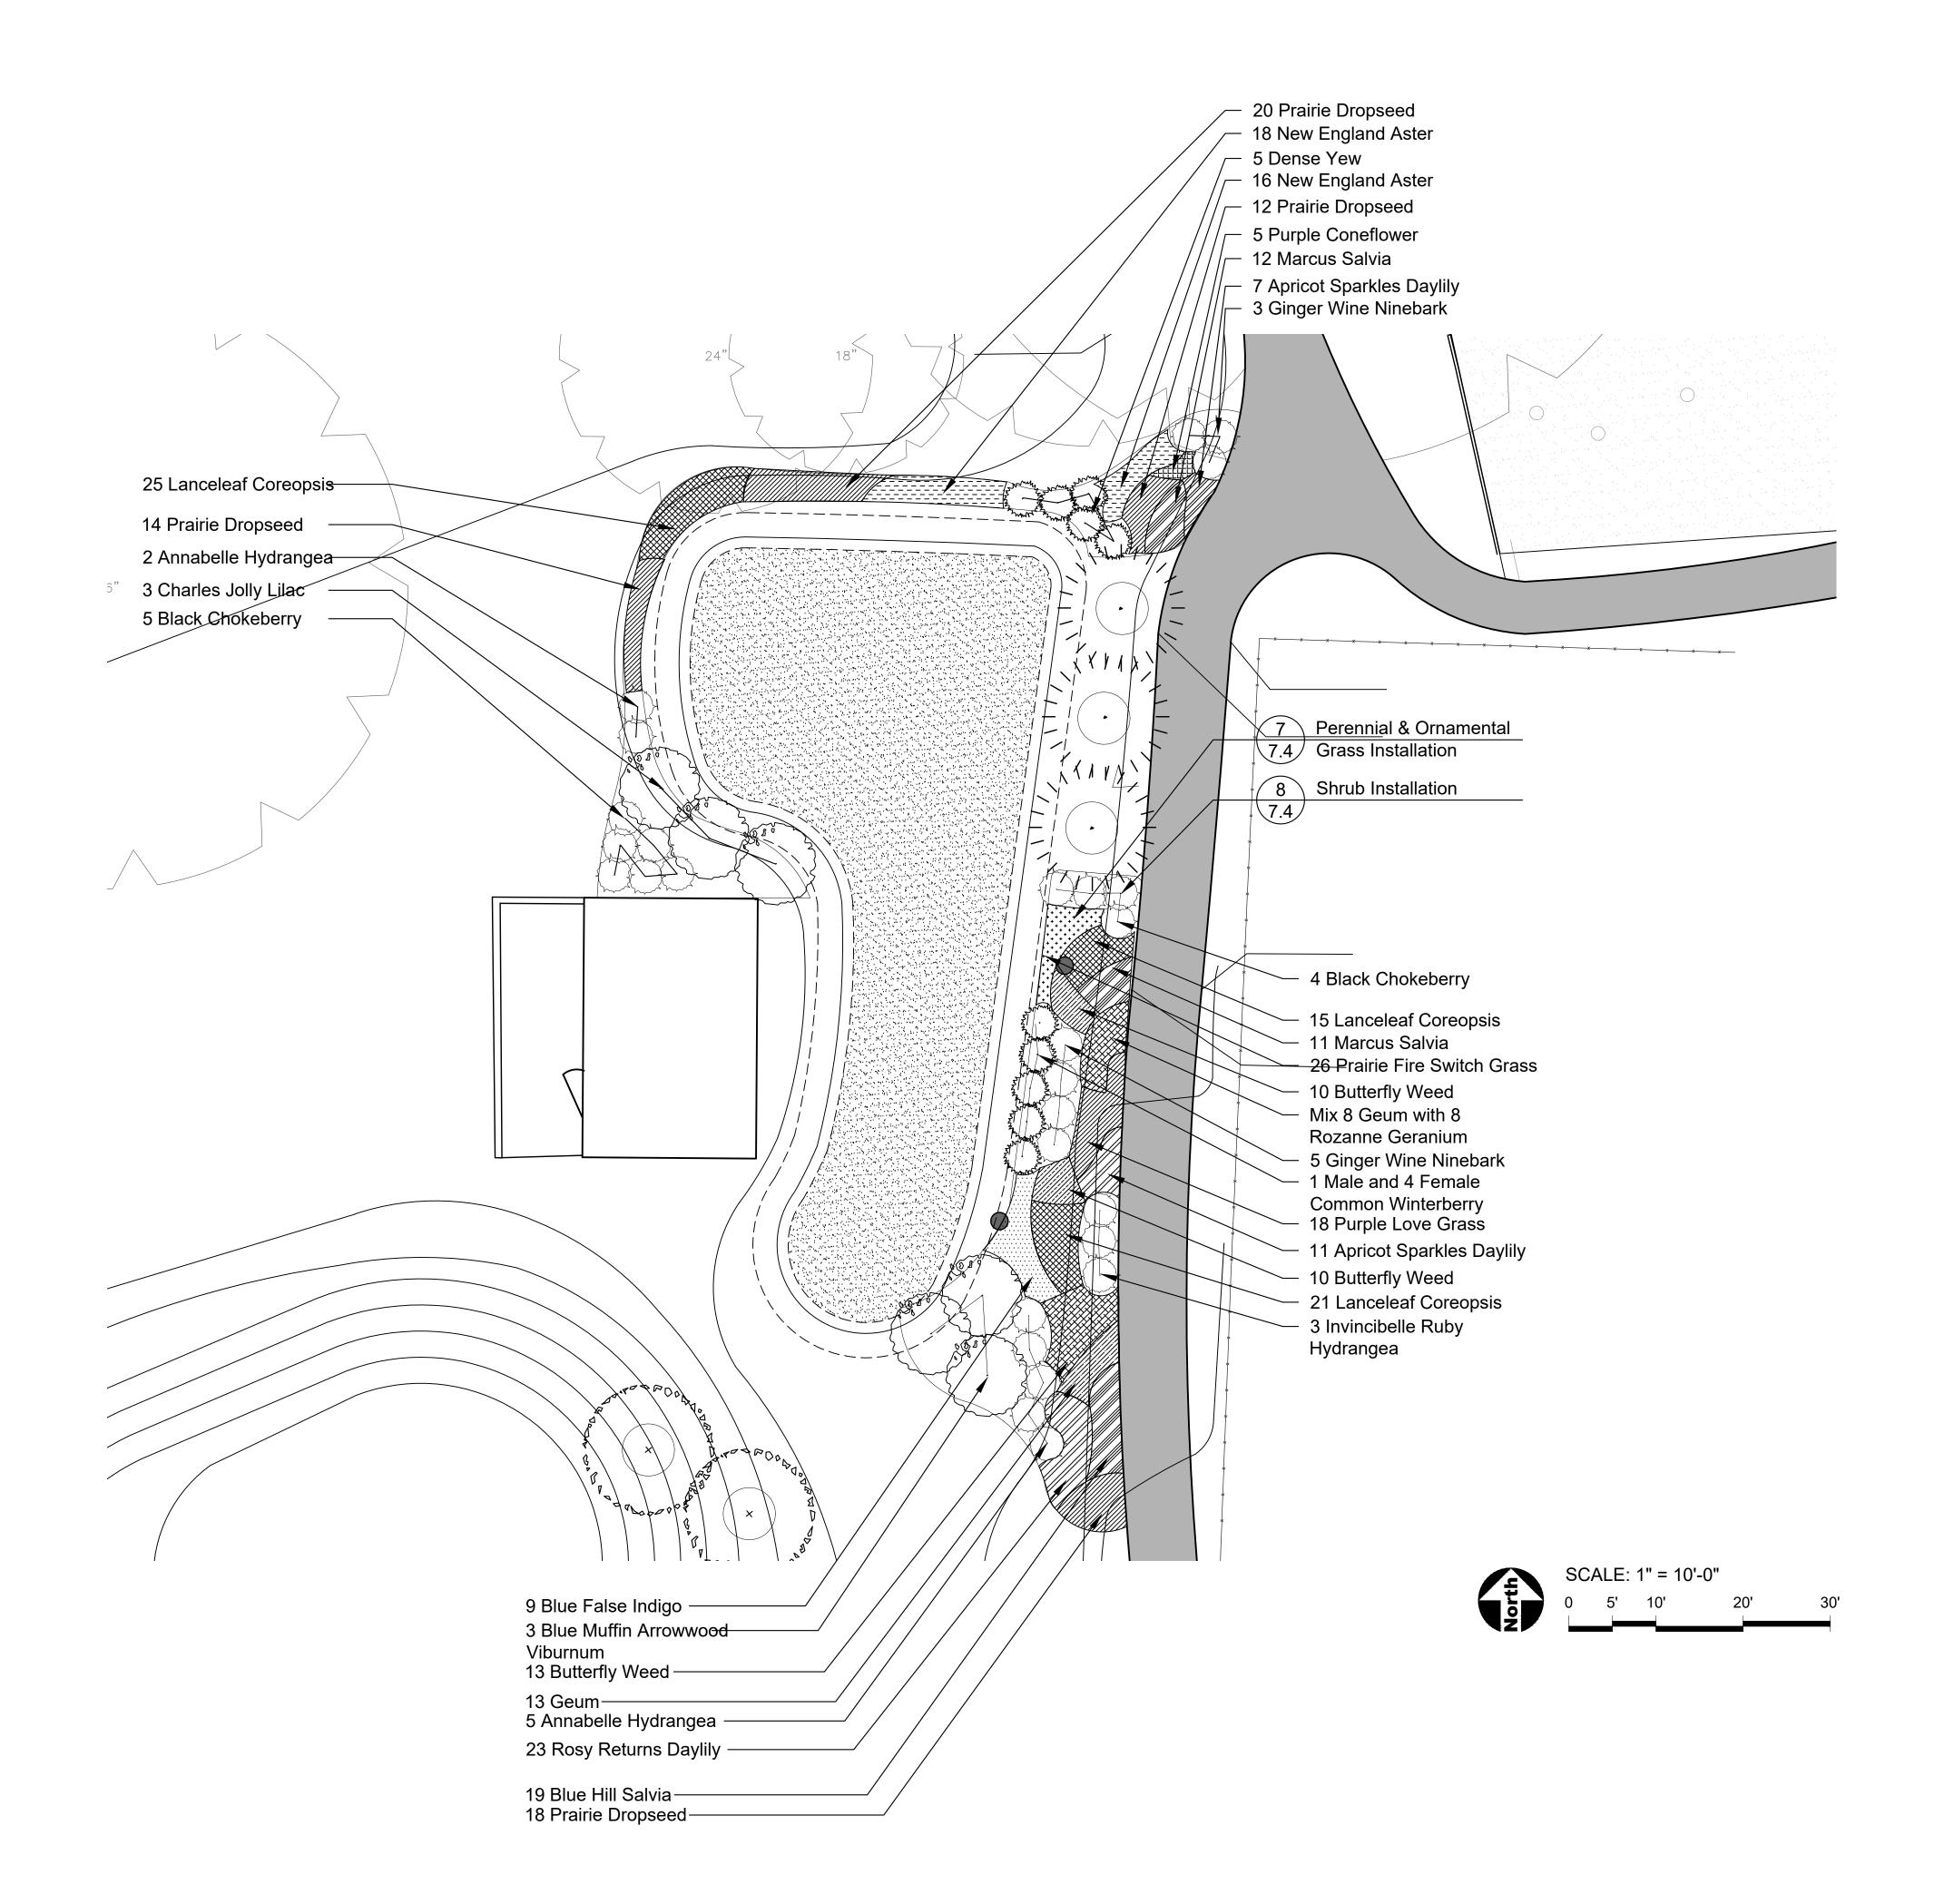

GENERAL NOTES: LANDSCAPE

1. See Sheet 6.0 for landscape notes.



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PROJECT

Glenbriar OSLAD Phase III Development

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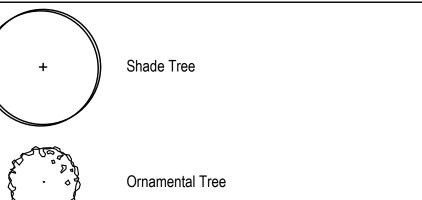
ENGINEER


Engineering Resource Associates 3S701 West Avenue Suite 150 Warrenville, IL 60555 Phone: 630-393-3060

SURVEYOR

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CL





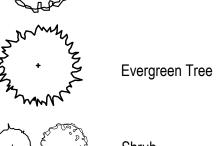

LEGEND

Ornamental Grass



Perennial and Groundcover (hatch symbol varies)

SHEET TITLE


Landscape Enlargement Bird Habitat 2

SHEET NUMBER

DRAW / REVISION

LD/JF Issue for Permit 17JUL2023

6.2

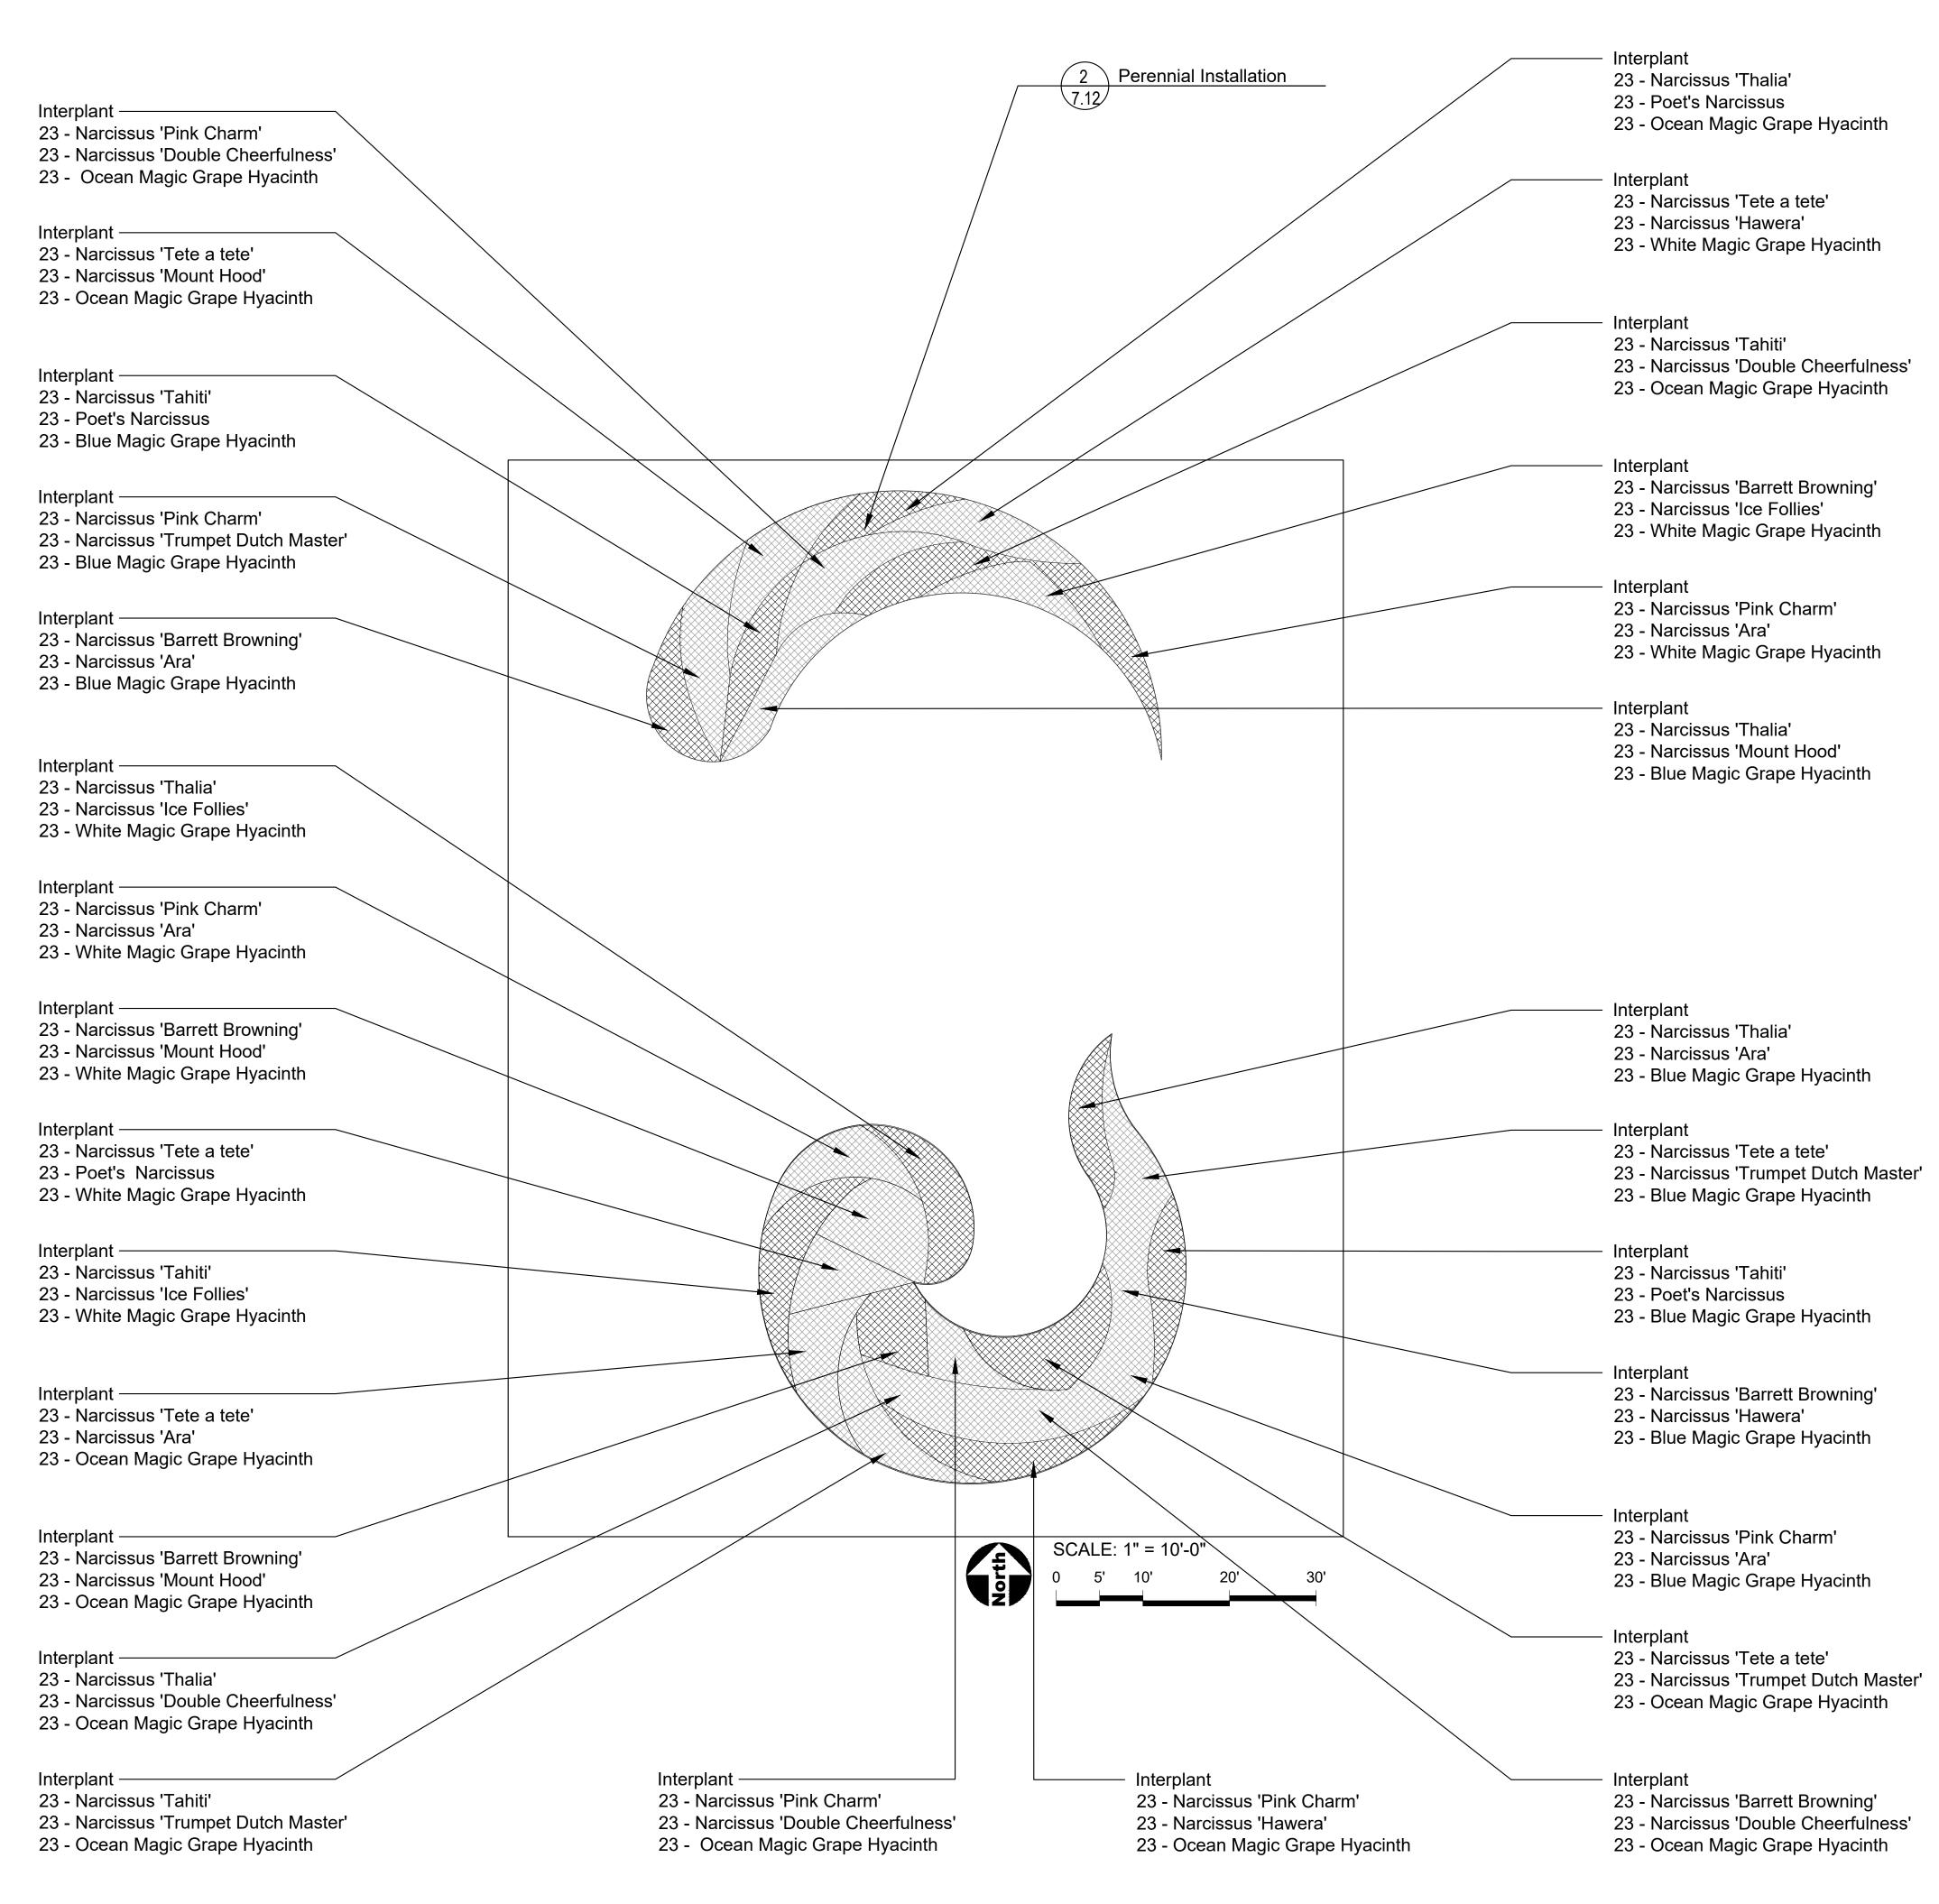

GENERAL NOTES: LANDSCAPE

- See Sheet 6.0 for landscape notes.
- 2. Bulbs shall be planted Fall 2023 and coordinate with irrigation plans.



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PROJECT

Glenbriar OSLAD Phase III Development

21W730 Butterfield Rd Lombard, Illinois 60148

PROJECT TEAM



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BULB LIST

| Bulbs | | | |
|-------|-------------|----------------------------------|---------------------------------|
| Qty. | Size | Botanical Name | Common Name |
| 207 | 12-14cm min | Muscari 'Blue Magic' | Blue Magic Grape Hyacinth |
| 276 | 12-14cm min | Muscari 'Ocean Magic' | Ocean Magic Grape Hyacinth |
| 184 | 12-14cm min | Muscari 'White Magic' | White Magic Grape Hyacinth |
| 69 | 12-14cm min | Narcissus poeticus var. recurvus | Poet's Narcissus |
| 69 | 12-14cm min | Narcissus 'Ice Follies' | Daffodil 'Ice Follies' |
| 92 | 12-14cm min | Narcissus 'Mount Hood' | Daffodil 'Mount Hood' |
| 138 | 12-14cm min | Narcissus 'Tete a tete' | Daffodil 'Tete a tete' |
| 69 | 12-14cm min | Narcissus 'Hawera' | Triandrus Daffodil |
| 161 | 12-14cm min | Narcissus 'Pink Charm' | Daffodil 'Pink Charm' |
| 138 | 12-14cm min | Narcissus 'Barrrett Browning' | Daffodil 'Barrett Browning' |
| 92 | 12-14cm min | Narcissus 'Trumpet Dutch Master' | Daffodil 'Trumpet Dutch Master' |
| 115 | 12-14cm min | Narcissus 'Cheerfulness' | Daffodil 'Double Cheerfulness' |
| 115 | 12-14cm min | Narcissus 'Thalia' | Daffodil 'Thalia' |
| 115 | 12-14cm min | Narcissus 'Tahiti' | Daffodil 'Tahiti' |
| 138 | 12-14cm min | Narcissus 'Ara' | Daffodil 'Ara' |
| 1978 | Total | | , |


SHEET TITLE

Landscape Enlargement -**Bulb Planting** 6.3

SHEET NUMBER

DRAW / REVISION

| Issue for Permit | 17JUL2023 |
|------------------|---------------|
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| | nber 999-1117 |

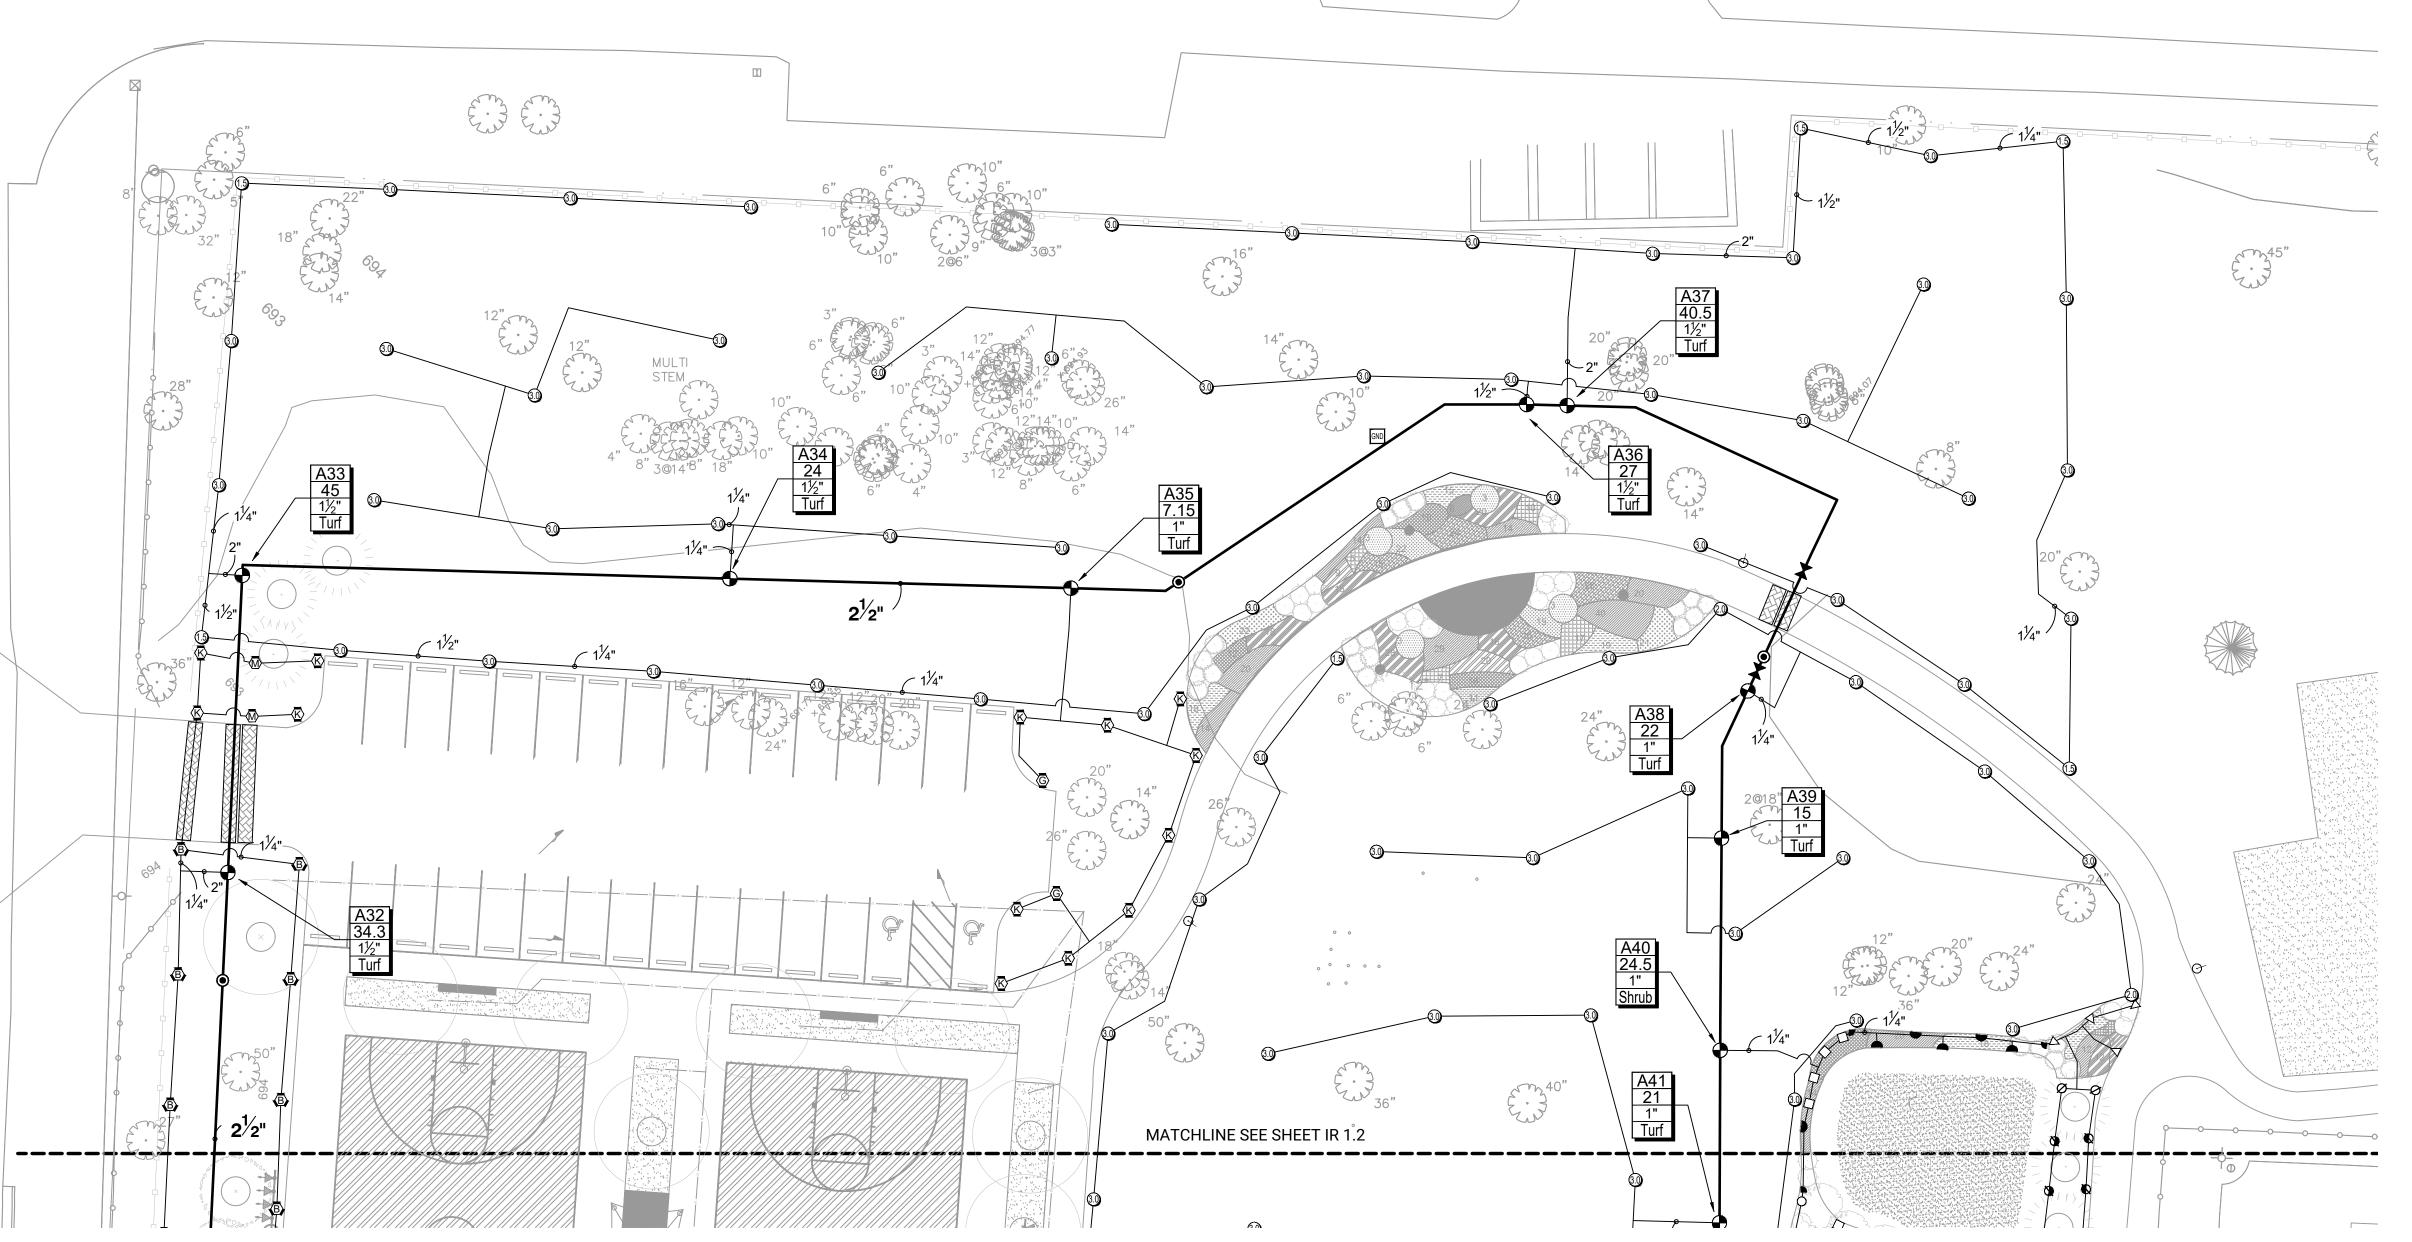

INSTALLATION GENERAL NOTES

- 1. THE SYSTEM DESIGN ASSUMES A MINIMUM DYNAMIC PRESSURE FOR THE IRRIGATION SYSTEM OF 80 PSI (PER CITY ENGINEER), AT A DESIGN FLOW OF 88 GPM AT THE 2-INCH IRRIGATION POINT-OF-CONNECTION (POC). TAP, METER, BACKFLOW PREVENTER, MASTER VALVE AND FLOW METER SHALL BE SIZED AS INDICATED IN THE DRAWING LEGEND. VERIFY PRESSURE AND FLOW ON SITE PRIOR TO CONSTRUCTION.
- 2. READ THOROUGHLY AND BECOME FAMILIAR WITH THE SPECIFICATIONS AND INSTALLATION DETAILS FOR THIS AND RELATED WORK PRIOR TO CONSTRUCTION.
- 3. COORDINATE UTILITY LOCATES ("CALL BEFORE YOU DIG") OF UNDERGROUND UTILITIES PRIOR TO CONSTRUCTION.
- 4. DO NOT PROCEED WITH THE INSTALLATION OF THE IRRIGATION SYSTEM WHEN IT IS OBVIOUS IN THE FIELD THAT OBSTRUCTIONS OR GRADE DIFFERENCES EXIST THAT MIGHT NOT HAVE BEEN CONSIDERED IN THE ENGINEERING. IF DISCREPANCIES IN CONSTRUCTION DETAILS, LEGEND, NOTES, OR SPECIFICATIONS ARE DISCOVERED, BRING ALL SUCH OBSTRUCTIONS OR DISCREPANCIES TO THE ATTENTION OF THE OWNER'S REPRESENTATIVE.
- 5. THE DRAWINGS ARE DIAGRAMMATIC. THEREFORE, THE FOLLOWING SHOULD BE NOTED:
- A. ALTHOUGH IRRIGATION COMPONENTS MAY BE SHOWN OUTSIDE PLANTING AREAS FOR CLARITY, INSTALL IRRIGATION PIPE AND WIRING IN LANDSCAPED AREAS WHENEVER POSSIBLE.
- B. TREE AND SHRUB LOCATIONS AS SHOWN ON LANDSCAPE PLANS TAKE PRECEDENCE OVER IRRIGATION EQUIPMENT LOCATIONS. AVOID CONFLICTS BETWEEN THE IRRIGATION SYSTEM, PLANTING MATERIALS, AND ARCHITECTURAL FEATURES.
- C. USE ONLY STANDARD TEES AND ELBOW FITTINGS. USE OF TEES IN THE BULLNOSE CONFIGURATION, OR USE OF CROSS TYPE FITTINGS IS NOT ALLOWED.

- PROVIDE THE FOLLOWING COMPONENTS TO THE OWNER PRIOR TO THE COMPLETION OF THE PROJECT:
- A. TWO (2) OPERATING KEYS FOR EACH TYPE OF MANUALLY OPERATED
- B. TWO (2) OF EACH SERVICING WRENCH OR TOOL NEEDED FOR COMPLETE ACCESS, ADJUSTMENT, AND REPAIR OF ALL ROTARY SPRINKLERS.
- 7. SELECT NOZZLES FOR SPRAY AND ROTARY SPRINKLERS WITH ARCS WHICH PROVIDE COMPLETE AND ADEQUATE COVERAGE WITH MINIMUM OVERSPRAY FOR THE SITE CONDITIONS. CAREFULLY ADJUST THE RADIUS OF THROW AND ARC OF COVERAGE OF EACH ROTARY SPRINKLER TO PROVIDE THE BEST PERFORMANCE.
- 8. THE IRRIGATION CONTRACTOR IS RESPONSIBLE FOR THE INSTALLATION OF IRRIGATION SLEEVING. SLEEVES ARE REQUIRED FOR BOTH PIPING AND ELECTRICAL WIRING AT EACH HARDSCAPE CROSSING. COORDINATE INSTALLATION OF SLEEVING WITH OTHER TRADES. ANY PIPE OR WIRE WHICH PASSES BENEATH EXISTING HARDSCAPE WHERE SLEEVING WAS NOT INSTALLED WILL REQUIRE HORIZONTAL BORING BY THE IRRIGATION CONTRACTOR. PIPE SLEEVES SHALL BE SIZED TWICE THE NOMINAL SIZE OF THE PIPE PASSING THROUGH.
- INSTALL ALL ELECTRICAL POWER TO THE IRRIGATION CONTROL SYSTEM IN ACCORDANCE WITH THE NATIONAL ELECTRIC CODE AND ALL APPLICABLE LOCAL ELECTRIC UTILITY CODES.
- 10. THE FOLLOWING SHOULD BE NOTED REGARDING PIPE SIZING: IF A SECTION OF UNSIZED PIPE IS LOCATED BETWEEN TWO IDENTICALLY SIZED SECTIONS, THE UNSIZED PIPE IS THE SAME NOMINAL SIZE AS THE TWO SIZED SECTIONS. THE UNSIZED PIPE SHOULD NOT BE CONFUSED WITH THE DEFAULT PIPE SIZE NOTED IN THE LEGEND.
- 11. INSTALL ONE (1) #14 AWG TWO-WIRE PAIR ON TWO-WIRE SYSTEMS , FOR USE AS SPARES. INSTALL SPARE WIRES FROM CONTROLLER LOCATION TO EACH DEAD-END OF MAINLINE. COIL 3 FEET OF WIRE IN VALVE BOX.

CONSTRUCTION NOTES

- THE IRRIGATION SYSTEM POINT-OF-CONNECTION (POC) SHALL BE DOWNSTREAM OF THE IRRIGATION WATER TAP AND METER INSTALLED BY OTHERS AT THE APPROXIMATE LOCATION SHOWN. INSTALL BACKFLOW PREVENTION UNIT AND MASTER VALVE ASSEMBLY AS INDICATED. VERIFY EXACT LOCATION OF POC WITH OWNER'S REPRESENTATIVE.
- WALL MOUNT THE IRRIGATION CONTROLLER AT THE APPROXIMATE LOCATION SHOWN. COORDINATE ELECTRICAL POWER TO THE CONTROLLER WITH THE OWNER'S REPRESENTATIVE. CARE SHOULD BE TAKEN TO INSTALL THE IRRIGATION CONTROLLER IN A LOCATION THAT IS ACCESSIBLE FOR MAINTENANCE, AND SCREENED FROM VIEW EITHER BEHIND ENTRY WALLS, NEXT TO BUILDINGS, OR BEHIND PLANT MATERIAL. FINAL LOCATION TO BE APPROVED BY OWNER'S REPRESENTATIVE.
- 3 IRRIGATION LINES AND HEADS LOCATED WITHIN TREE PROTECTION FENCES [TPF] SHALL BE INSTALLED BY HAND TO AVOID DAMAGE TO EXISTING TREES.

ESTIMATED ANNUAL WATER USE

THE IRRIGATION SYSTEM AS SHOWN ON THIS PLAN HAS AN ESTIMATED ANNUAL WATER USE OF 2,029,960 GALLONS. TO VERIFY EFFICIENT IRRIGATION SYSTEM OPERATION, THE OWNER SHALL COMPARE THIS ESTIMATED IRRIGATION WATER USE WITH ACTUAL WATER USE, AS RECORDED ON SITE, AFTER ALL PLANT MATERIAL HAS BEEN ESTABLISHED.

THE ESTIMATED ANNUAL IRRIGATION WATER USE OF THIS SYSTEM IS BASED ON 30-YEARS AVERAGE EVAPOTRANSPIRATION RATES (ET) FOR THE LOCAL AREA AND TYPICAL NEW IRRIGATION SYSTEM EQUIPMENT EFFICIENCIES. MAJOR DEVIATIONS FROM THIS ESTIMATE USE SHOULD BE BROUGHT TO THE ATTENTION OF THE OWNER AND CURRENT IRRIGATION MAINTENANCE COMPANY AT THE TIME OF THE DEVIATION.

TO VERIFY EFFICIENT IRRIGATION SYSTEM OPERATION AND WATER USE, AN IRRIGATION SYSTEM EVALUATION AND AUDIT SHOULD BE PERFORMED.

IRRIGATION SLEEVE LEGEND

* ALL SLEEVES SHALL BE CLASS 200 PVC AND SIZED TWICE THE NOMINAL SIZE OF THE PIPE PASSING THROUGH, ALL CONTROL WIRE SLEEVES SHALL BE 2-INCH

IRRIGATION LEGEND

SLEEVES: CLASS 200 PVC

POINT-OF-CONNECTION ASSEMBLY

MAINLINE PIPE: CLASS 200 PVC

2 1/2-INCH SIZE UNLESS OTHERWISE INDICATED

LATERAL PIPE TO SPRINKLERS: CLASS 200 PVC
 1-INCH SIZE UNLESS OTHERWISE INDICATED

— UNCONNECTED PIPE CROSSING

- REMOTE CONTROL VALVE ASSEMBLY FOR SPRINKLER LATERALS: HUNTER ICV (SIZED PER PLAN) W/ICD-100 DECODER
- QUICK COUPLING VALVE ASSEMBLY: HUNTER HQ-5RC
- ISOLATION GATE VALVE ASSEMBLY: MATCO 514
- F FLOW SENSOR ASSEMBLY: HUNTER HFS WITH FCT-200 W/FLOW CLICK SENSOR
- BACKFLOW PREVENTION ASSEMBLY: FEBCO 825YA (2")
- MASTER VALVE ASSEMBLY: IRRITROL 100P1.5 N.O. VALVE W/ ICD-100 DECODER

 DECODER CABLE FUSE DEVICE (DCFD) WITH LIGHTNING PROTECTION: PAIGE P7407D



A IRRIGATION CONTROLLER UNIT WITH HUNTER WRF-CLIK SENSOR A2C-LTE COMMUNICATION MODULE HUNTER ACC2 2 WIRE CONTROLLER

POP-UP GEAR DRIVEN ROTORS: HUNTER I-20-06-SS PRESSURE: 45 PSI

| | PRESSUR | E: 45 PSI | | |
|------------|---------|-----------|---------|--|
| | NOZZLE | RADIUS | FLOW | |
| 1.5 | 1.5 | 31' | 1.5 GPM | |
| 2.0 | 2.0 | 34' | 2.0 GPM | |
| 2 5 | 2.5 | 35' | 2.5 GPM | |
| 3.0 | 3.0 | 38' | 3.0 GPM | |
| 4.0 | 4.0 | 40' | 4.0 GPM | |
| 5.0 | 5.0 | 42' | 5.0 GPM | |
| 6.0 | 6.0 | 43' | 6.0 GPM | |
| 8.0 | 8.0 | 44' | 8.0 GPM | |
| | | | | |

♦ ■ POP-UP SPRAY SPRINKLER: HUNTER PROS-12-PRS30-CV W/8 SERIES NOZZLE PRESSURE: 30 PSI RADIUS: 8 FEET FLOW (GPM): Q-0.24 H-0.47 F-0.97

SCALE: 1"=20' N O R

- Ø POP-UP SPRAY SPRINKLER: HUNTER PROS-12-PRS30-CV W/10 SERIES NOZZLE PRESSURE: 30 PSI RADIUS: 10 FEET FLOW (GPM): Q-0.42 H-0.88 F-1.59
- △ ▲ POP-UP SPRAY SPRINKLER: HUNTER PROS-12-PRS30-CV W/12 SERIES NOZZLE PRESSURE: 30 PSI RADIUS: 12 FEET FLOW (GPM): Q-0.67 H-1.30 F-2.70
- POP-UP SPRAY SPRINKLER: HUNTER PROS-12-PRS30-CV W/15 SERIES NOZZLE PRESSURE: 30 PSI RADIUS: 15 FEET FLOW (GPM): Q-0.97 H-1.86 F-3.75
- □ ७ △ POP-UP SPRAY SPRINKLER: HUNTER PROS-12-PRS30-CV W/ ADJUSTABLE NOZZLE PRESSURE: 30 PSI RADIUS: 5 FEET TO 15 FEET FLOW (GPM): 08A-0.44 10A-0.50 12A-0.32 15A-0.47
- POP-UP SPRAY SPRINKLER: HUNTER PROS-12-PRS30-CV W/15SS SERIES NOZZLE PRESSURE: 30 PSI RADIUS: 5 FEET X 15 FEET FLOW (GPM): ES515-0.65 SS530-1.30
- © POP-UP ROTATING SPRAY SPRINKLER: HUNTER PROS-06-PRS40-CV W/MP2000 NOZZLES PRESSURE: 40 PSI RADIUS: 13 FEET TO 21 FEET FLOW (GPM): K-0.77 G-1.10 R-1.48
- POP-UP ROTATING SPRAY SPRINKLER: HUNTER PROS-06-PRS40-CV W/MP3000 NOZZLES
 PRESSURE: 40 PSI RADIUS: 22 FEET TO 30 FEET
 FLOW (GPM): B-1.82 Y-2.73 A-3.64
- POP-UP ROTATING SPRAY SPRINKLER: HUNTER PROS-06-PRS40-CV W/MPCORNER NOZZLE PRESSURE: 40 PSI RADIUS: 8 FEET TO 14 FEET FLOW (GPM): 45°-0.19 90°-0.39 105°-0.45
- POP-UP ROTATING SPRAY SPRINKLER: HUNTER PROS-06-PRS40-CV W/MPSTRIP NOZZLES PRESSURE: 40 PSI RADIUS: ADJUSTABLE RECTANGULAR SPRAY FLOW (GPM): SST 5'X30'-0.22 LCS/RCS 4'X15'-0.44

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PROJECT

Glenbriar OSLAD Phase III Development

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PROJECT TEAM



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SITE WATER ENGINEERING SERVICES 323 W. DRAKE RD, SUITE 204 FORT COLLINS, COLORADO 80526 Telephone: 970.282.1800 Web: www.hinesinc.com

SHEET TITLE
IRRIGATION PLAN

SHEET NUMBER IR-1.1

DRAW / REVISION

| LD/JF | 50% Submittal | 15JUN2023 |
|-------|----------------|-----------|
| DM/MT | 100% Submittal | 30JUN2023 |
| DM/MT | REVISIONS | 04AUG2023 |
| | | |
| | | |



PROJECT

Glenbriar OSLAD Phase III Development

21W730 Butterfield Rd Lombard, Illinois 60148

PROJECT TEAM



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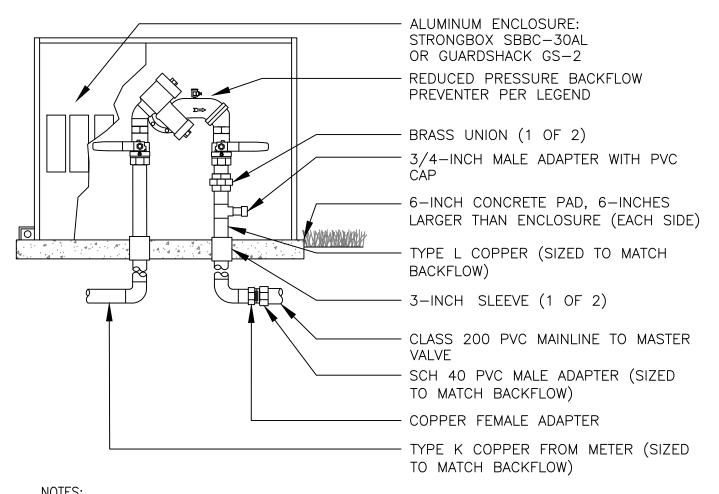
SHEET TITLE
IRRIGATION PLAN

SHEET NUMBER IR-1.2 DRAW / REVISION

LD/JF 50% Submittal 15JUN2023


DM/MT 100% Submittal 30JUN2023

DM/MT REVISIONS 04AUG2023




- 1. INSTALL BACKFLOW DEVICE IN ACCORDANCE WITH ALL STATE AND LOCAL CODE REQUIREMENTS.
 2. SLOPE TOP SURFACE OF PAD AT 0.5 % WITH BROOM FINISH.
- MAKE PIPE SLEEVES WITH 1-1/2 INCH LARGER DIAMETER PIPE THAN PENETRATING PIPE SIZE.
 ALL HINGED CONNECTION LOCATIONS AND HARDWARE TO BE TAMPER PROOF.
 ALL WELD JOINTS SHALL BE CONTINUOUS AND GROUND SMOOTH.

1 BACKFLOW PREVENTION UNIT ASSEMBLY

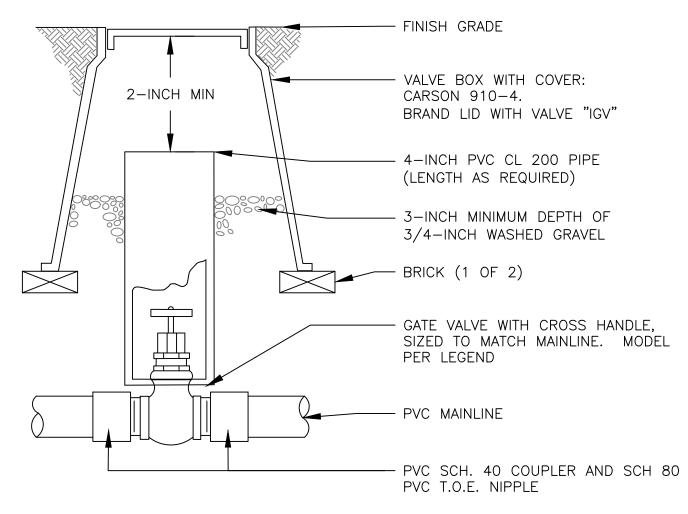

NOTES:
1. NOMINAL SIZE OF GATE VALVE TO MATCH NOMINAL MAINLINE SIZE.

5 ISOLATION GATE VALVE ASSEMBLY 2.5-INCH MAINLINE AND SMALLER

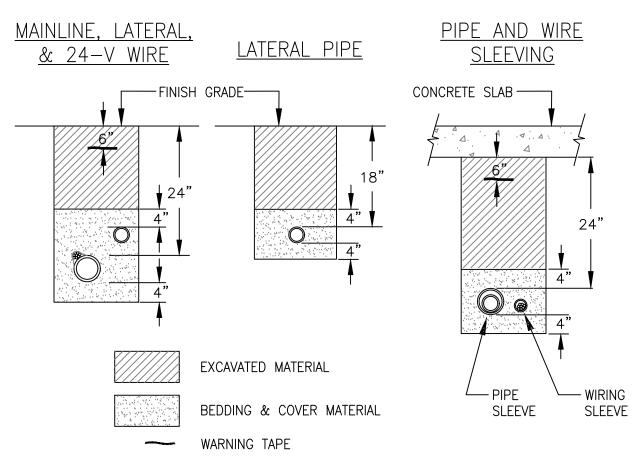


NOTES:


1. SLEEVE ALL PIPE AND WIRE SEPARATELY.
2. ALL PIPE TO BE INSTALLED PER MANUFACTURER'S SPECIFICATIONS."SNAKE" UNSLEEVED PLASTIC PIPE IN TRENCH. PROVIDE A MINIMUM OF 2" CLEARANCE TO SIDE OF TRENCH

3. ALL 120-V WIRING SHALL BE INSTALLED IN ACCORDANCE WITH LOCAL CODE REQUIREMENTS. PROVIDE LOOSE 20" LOOP OF 2-WIRE CABLE AT ALL CHANGES OF DIRECTION OVER 30 DEGREES.




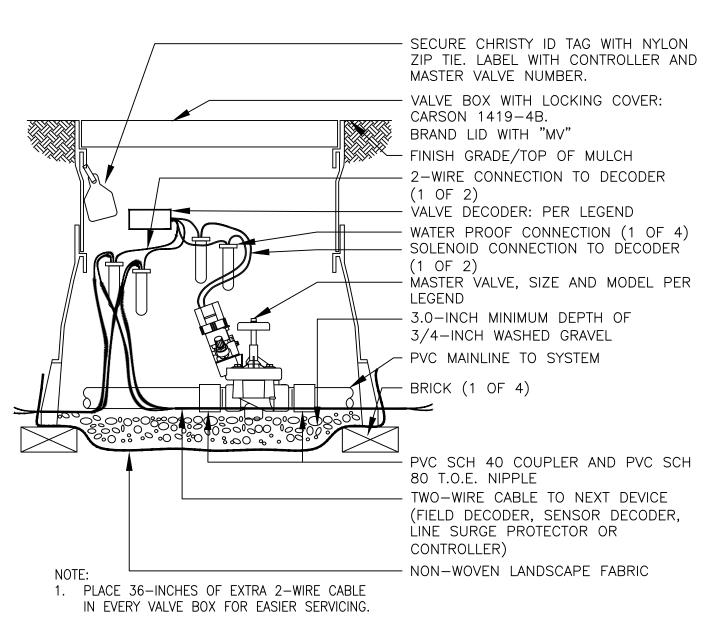

2 MASTER VALVE ASSEMBLY

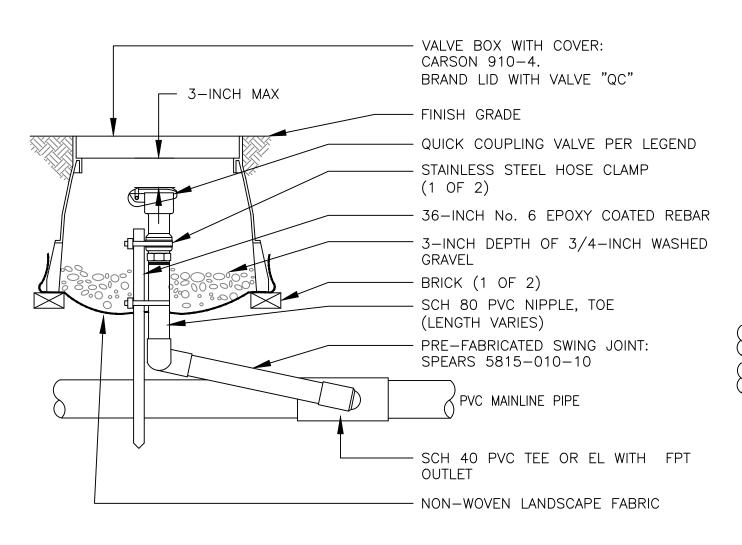


6 QUICK COUPLING VALVE ASSEMBLY

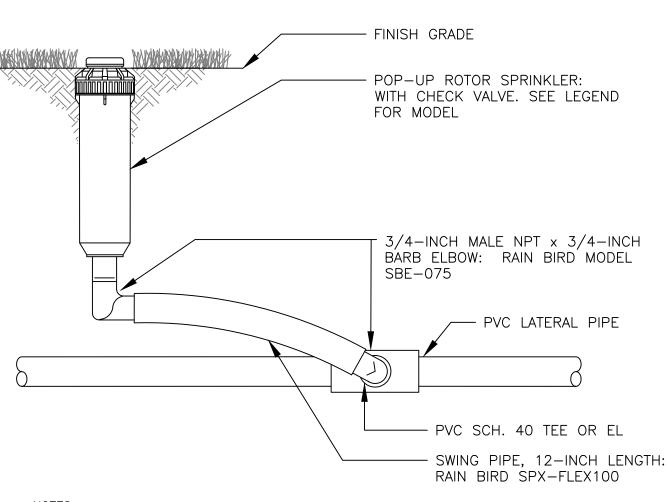


NOTES:
1. INSTALL PLASTIC RISERS FOR ROTORS IN NATIVE AREAS.

6-INCH GEAR DRIVEN
ROTOR ASSEMBLY

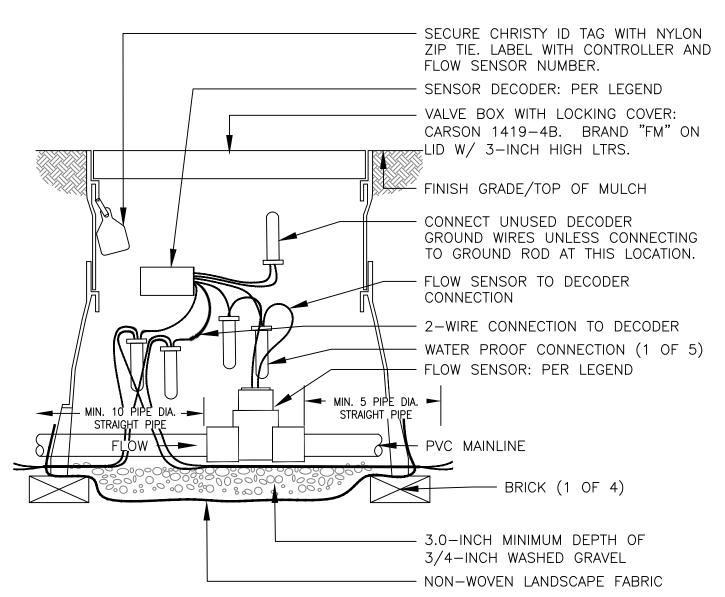

FLOW SENSOR ASSEMBLY

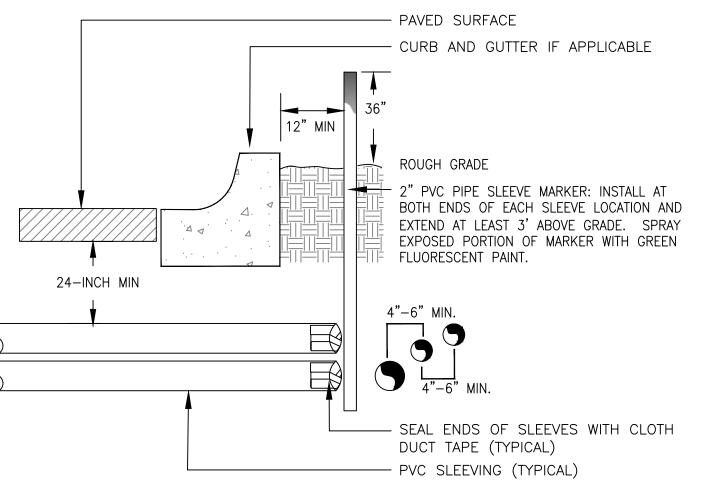


NOTE:


1) ALL SLEEVING TO BE CLASS 200 BE PVC, SIZED AS NOTED.

2) INSTALL SLEEVES IN SIDE—BY—SIDE CONFIGURATION WHERE MULTIPLE SLEEVES ARE TO BE INSTALLED. SPACE SLEEVES 4" TO 6" APART. DO NOT STACK SLEEVES VERTICALLY.


7 TYPICAL SLEEVING DETAIL

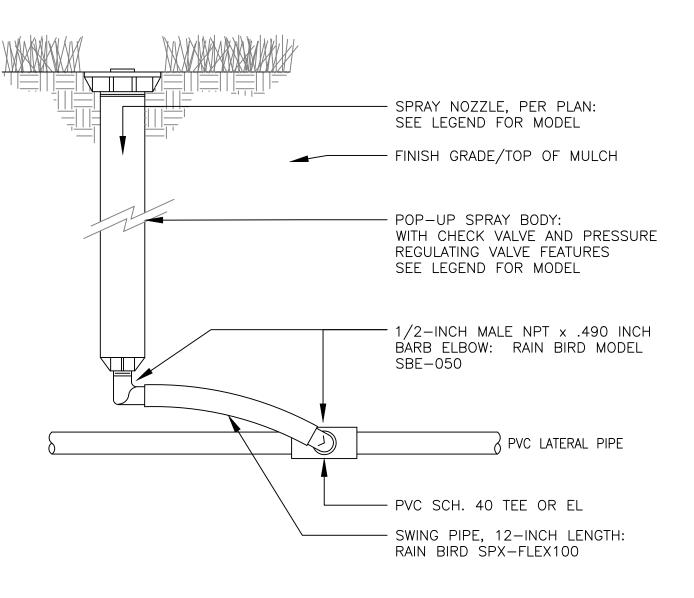

(11) 12-INCH POP UP SPRAY SPRINKLER ASSEMBLY

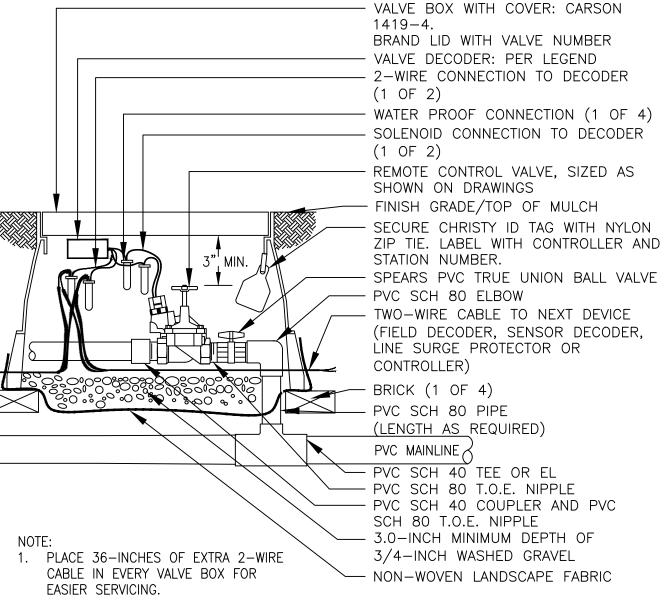

REMOTE CONTROL SPRINKLER VALVE ASSEMBLY

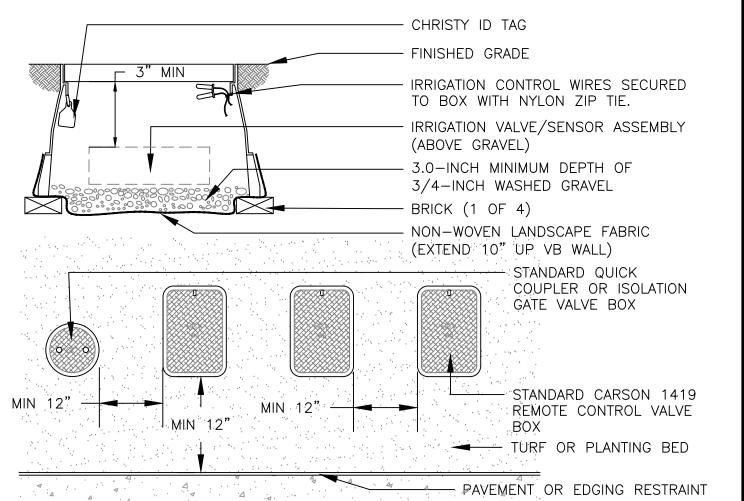


NOTES:

1. INSTALL ONLY ONE RCV TO VALVE BOX. LOCATE AT LEAST 12—INCHES FROM AND ALIGN WITH NEARBY WALLS OR EDGES OF PAVED AREAS. GROUP RCV ASSEMBLIES TOGETHER WHERE PRACTICAL.

4. GROUP RCV ASSEMBLIES TOGETHER WHERE PRACTICAL, BUT AVOID GROUPING MORE THAN THREE (3) STANDARD VALVE BOXES TOGETHER IN A SERIES.

5. ARRANGE GROUPED VALVE BOXES IN RECTANGULAR PATTERNS.

8 TYPICAL VALVE BOX INSTALLATION

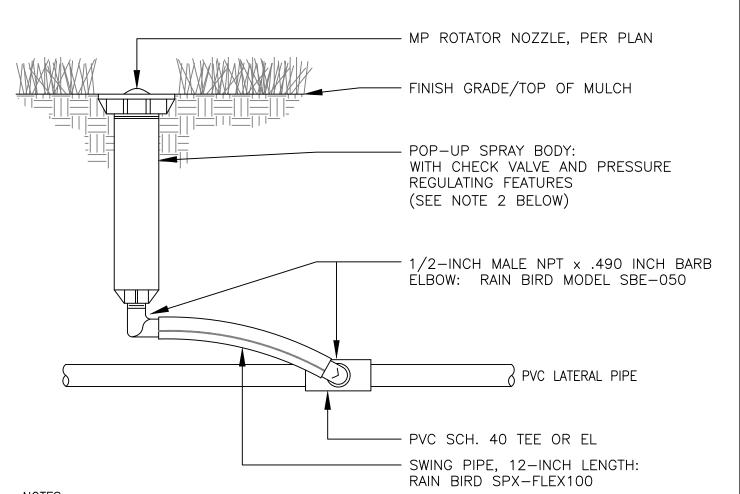

IF POLYETHYLENE PIPE IS USED FOR LATERAL PIPE, SUBSTITUTE INSERT TEE OR EL WITH STAINLESS STEEL CLAMPS FOR PVC SLIP TEE OR EL SHOWN ABOVE.
 TO ACHIEVE MINIMUM RADIUS WITH ANY MP ROTATOR MODEL, USE 30 PSI PRESSURE REGULATING SPRAY BODY.

6-INCH POP UP MP-ROTATOR ASSEMBLY 21W730 Butterfield Rd Lombard, Illinois 60148 Phone: 630-858-2229

PROJECT

Glenbriar OSLAD Phase III Developmen

21W730 Butterfield Rd Lombard, Illinois 60148





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SHEET TITLE
IRRIGATION DETAILS


SHEET NUMBER IR-2.1

IR-2.1 DRAW / REVISION

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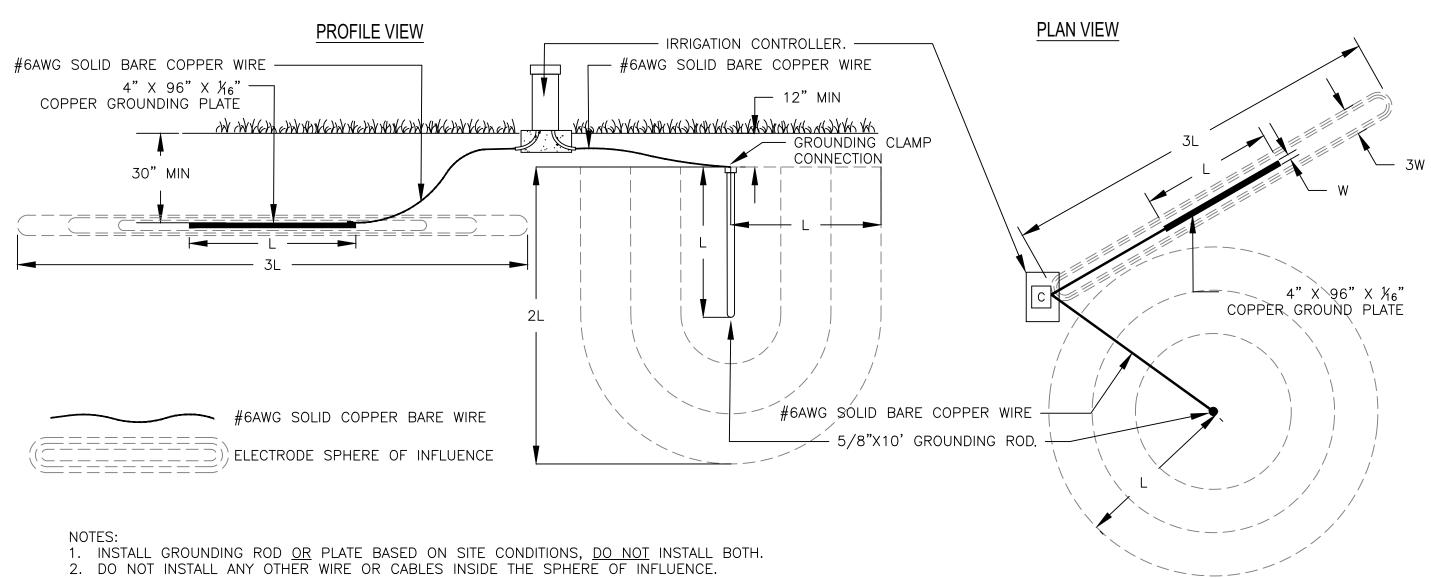
Project Number 999-1117
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ROTOR ASSEMBLY



CLOSE PROXIMITY TO CONTROLLER, INSTALL ONE (1) DRIP EMITTER FROM NEAREST DRIP VALVE IN VALVE BOX HOUSING GROUNDING ROD.

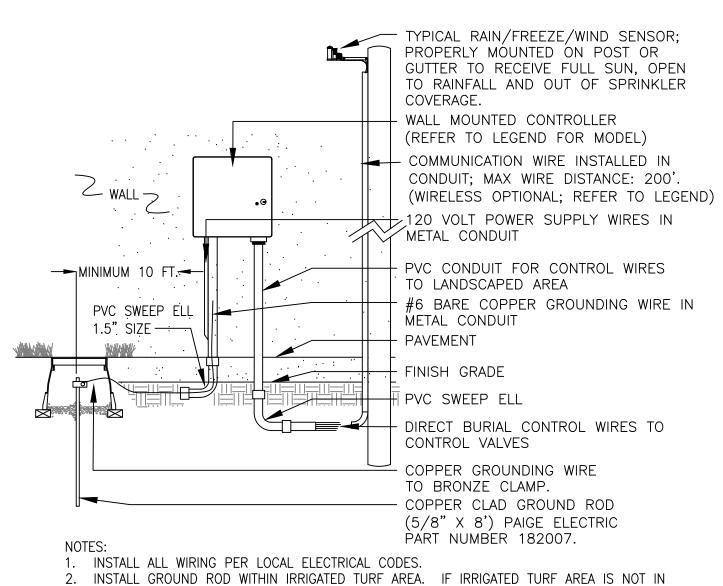



- 3. INSTALL GROUNDING PLATE AT A MINIMUM OF 30—INCHES BELOW GRADE OR BELOW FROST—LINE, WHICHEVER IS DEEPER.
- 4. TYPICAL INSTALLATION SHOWN FOR AN IRRIGATION CONTROLLER CAPACITY OF 64 STATIONS OR LESS, INSTALL AN ADDITIONAL GROUNDING ROD/PLATE PER 64 STATIONS.

14) TYPICAL IRRIGATION CONTROLLER GROUNDING ROD OR PLATE INSTALLATION

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PROJECT TEAM



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SHEET TITLE
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